

CITY OF ST. PETERSBURG, FLORIDA

PLANNING AND DEVELOPMENT SERVICES DEPARTMENT
URBAN PLANNING AND HISTORIC PRESERVATION DIVISION

STAFF REPORT

Community Planning and Preservation Commission Certificate of Appropriateness Request

Report to the Community Planning and Preservation Commission from the Urban Planning and Historic Preservation Division, Planning and Development Services Department, for Public Hearing and Executive Action scheduled for **Tuesday**, **June 8**, **2021**, **beginning at 2:00 p.m.**, in Council Chambers of City Hall, 175 Fifth St. N., St. Petersburg, Florida. Everyone is encouraged to view the meetings on TV or online at www.stpete.org/meetings.

According to Planning and Development Services Department records, Commissioner Jeff Wolf resides or has a place of business within 2,000 feet of the subject property. All other possible conflicts should be declared upon the announcement of the item.



Case No.: COA 21-90200045; AVT 21-90400004

Request: Review of a Certificate of Appropriateness for the window replacement and

rehabilitation at 217 10th Ave NE, a contributing property to a local historic district

Legal Description: BAYVIEW ADD BLK 8, E 20FT OF LOT 8 & W 55FT OF LOT 9

Parcel ID No.: 18-31-17-05274-008-0090

Date of Construction: 1920

Local Landmark: North Shore Section – 200 Block of 10th Avenue Northeast Local Historic District

(17-90300004)

Owners: Michael Hussey

Mary Ellen Hussey

Applicant: Andrej Klobucar, Contractor, Konstrukt Builders, Inc.

Historical Context and Significance

The Craftsman style house at 217 10th Ave. NE was constructed in 1920. It appears that the existing garage apartment was constructed at that time as a single-story garage, as it appears in the 1923 Sanborn map shown in Figure 1. The second story was added as servants' quarters in 1936 according to permit records.

The subject property has been designated a contributing property to both the 200 Block of 10th Avenue Northeast Historic District (17-90300004) and North Shore National Register Historic District. Because of its location within the 200 Block of 10th Avenue Northeast Historic District, a Certificate of Appropriateness (COA) is required for exterior alteration. Per the City's COA Matrix, changes in materials of elements such as windows requires a public hearing before the Community Planning and Preservation Commission (CPPC). The Ad Valorem Tax (AVT) Exemption for Rehabilitation application Part 1, for which this property qualifies because of its contributing status to a historic district listed in the Local or National Register of Historic Places, is processed using parallel criteria to the COA

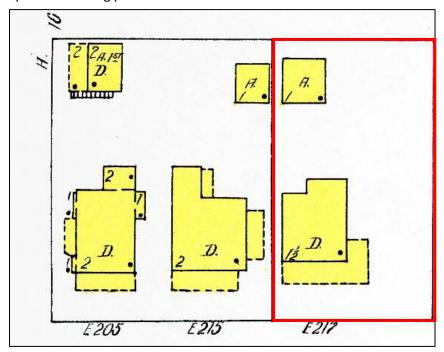


Figure 1: 1923 Sanborn map of subject property.

Project Description and Review

Project Description

This COA and AVT applications (Appendices A and B) propose alteration to the subject property by: Exterior (subject to COA and AVT review):

- Constructing a new inground swimming pool,
- Removing non-historic windows to open the primary residence's original porch,
- Replacing historic wood windows with impact windows replicating originals' size and configuration,
- Infilling several window openings at the rear of the primary residence's first floor,
- Installing a vinyl fence at side and rear yard,

• Relocating mechanical equipment to rear side of west elevation of primary residence.

Interior (subject to AVT review only):

- Mechanical work to include electrical, plumbing and HVAC upgrades,
- Interior rehabilitation (qualifying costs include walls, ceiling, and permanent floor coverings but not fixtures such as cabinetry).

The owners have recently purchased and plan to rehabilitate the entire property, including the garage apartment. Plans as originally submitted included replacement of the stairs to the detached garage apartment's second floor living space and replacement of its windows and doors. Following the submission of the application, a fire occurred at the detached garage, causing a degree of damage not fully known as of the writing of this report. As such, this item will consider work to the primary residence and landscape only; the rehabilitation – or possible demolition and new construction – of the garage apartment will be considered at a later time through a separate COA and revision to the AVT application once the scope of work is determined.

General Criteria for Granting Certificates of Appropriateness and Staff Findings

1. The effect of the proposed work on the landmark or the property upon which such work is to be done.

Generally consistent

The proposed project will certainly have a positive impact on the district as a whole by reopening the historic front porch, which is a very significant and character-defining element of the subject property as a contributing property to the local historic district.

The replacement of the existing wood windows will remove a historic material and introduce vinyl impact windows, which will diminish the subject property's material integrity. However, the applicant has stated that the historic windows are irreparable. The replacements will replicate historic size and configuration and therefore generally retain integrity of design.



Figure 2: Enclosed front porch at subject property. Facing northwest.

CPPC Case Nos.: 21-90200045 and 21-90400004

Figure Error! Main Document Only.:

2. The relationship between such work and other structures on the landmark site or other property in the historic district.

Consistent

As stated above, the restoration of the subject property's large front porch will have a positive impact on the subject district's streetscape.

3. The extent to which the historic, architectural, or archaeological significance, architectural style, design, arrangement, texture and materials of the local landmark or the property will be affected.

Partially consistent

The new material of the windows will affect the property's integrity. Other aspects of the proposal satisfy this criterion.

4. Whether the denial of a Certificate of Appropriateness would deprive the property owner of reasonable beneficial use of his or her property.

Information not provided

5. Whether the plans may be reasonably carried out by the applicant.

Consistent

There is no indication that the applicant cannot carry out the proposal.

6. A COA for a noncontributing structure in a historic district shall be reviewed to determine whether the proposed work would negatively impact a contributing structure or the historic integrity of the district. Approval of a COA shall include any conditions necessary to mitigate or eliminate negative impacts.

Not applicable

The subject property is listed as a contributing property.

Additional Guidelines for Alterations

1. A local landmark should be used for its historic purpose or be placed in a new use that requires minimal change to the defining characteristics of the building and its site and environment.

Consistent

The subject property is, and will continue to be, a single-family residence.

2. The distinguishing historic qualities or character of a building, structure, or site and its environment shall be preserved. The removal or alteration of any historic material or distinctive architectural features shall be avoided when reasonable.

Consistent

As noted above, the reopened front porch will restore a degree of now-concealed historic character of the subject property. The window replacement will change materials and visual texture but replicate the historic configuration and therefore maintain historic design.

3. Each property shall be recognized as a physical record of its time, place, and use. Changes that create a false sense of historical development, such as adding conjectural features or architectural elements from other buildings without sufficient documentary evidence, shall not be undertaken.

Consistent

4. Most properties change over time; those changes that have acquired historic significance in their own right shall be retained and preserved, as appropriate.

Consistent

The existing porch enclosure is not listed in City permit records but appears to date to the 1970s-1990s by the method of construction. No alterations which have gained historic significance will be affected by the proposed project.

5. Distinctive features, finishes, and construction techniques or examples of craftsmanship that characterize a property shall be preserved.

Inconsistent

The proposal includes the introduction of several materials that would not historically have been available, including vinyl impact windows and vinyl fencing. However, particularly with the inclusion of the staff-recommended Conditions of Approval, the proposal does satisfy St. Petersburg's Design Guidelines.

6. Deteriorated historic features shall be repaired rather than replaced. Where the severity of deterioration requires replacement of a distinctive feature, the new feature shall match the old in design, texture, and other visual qualities and, where reasonable, materials. Replacement of missing features shall be substantiated by documentary, physical, or pictorial evidence.

Partially consistent

The proposal does include replacing historic windows of the main house. The applicant has stated that they are highly deteriorated and staff has observed areas of rot and termite damage on site visits.

7. Chemical or physical treatments, such as sandblasting, that cause damage to historic materials shall not be used. The surface cleaning of structures, if appropriate, shall be undertaken using the gentlest means possible.

Consistent

No harsh treatments have been proposed or observed.

8. Significant archaeological resources affected by a project shall be protected and preserved if designated pursuant to this section. If such resources must be disturbed, mitigation measures shall be undertaken.

Not applicable

The subject property is not located within a known archaeological sensitivity area.

Additional Guidelines for Window Replacement

The City's historic preservation office, State of Florida Division of Historic Resources, and U.S. Department of Interior Technical Preservation Services can provide additional information relating to window repair

and replacement for individual landmark buildings and properties within local historic districts. While preservation and repair of historic windows is often preferable, property owners may replace windows provided that each replacement window meets the following criteria:

1. Impact resistance. The replacement window and glass shall be impact resistant;

Consistent

2. Energy performance. The replacement window shall be Energy Star qualified for southern climate zones;

Consistent

3. Depth in wall. The replacement window shall be setback into the wall the same distance as the historic window;

Recommended condition of approval

4. Frame size, shape and exterior trim. The replacement window shall be the same size and shape as the historic window and opening. Historic openings shall not be altered in size. Existing, exterior trim shall be retained, where practicable;

Recommended condition of approval

5. Configuration. The replacement window shall have the same light configuration as the historic window. If the historic window configuration cannot be determined, the replacement window configuration shall be appropriate to the architectural style of the subject building;

Consistent

- 6. Proportions. The replacement window shall have the same visual qualities of the historic window, where commercially reasonable:
 - a. Muntins and mullions. Where provided, muntins and mullions shall have the same dimensions and profile of the historic muntins and mullions.
 - b. Stiles. For hung windows, stiles shall align vertically and be the same width at the upper and lower sashes.
 - c. Top, meeting and bottom rails, and blind stop. The top, meeting and bottom rails of a hung window, including the corresponding blind stop, shall have the same dimensions and profile of the historic window.

Generally consistent.

7. Finish. The finished surface and appearance shall match the historic window, where practicable.

Inconsistent

The vinyl material will be visual distinct from historic wood sashes, although the proposed windows do meet other criteria and are similar to those approved by this board in residential historic districts in recent cases.

Summary of Findings, Certificate of Appropriateness Review
Staff evaluation yields a finding of the following criteria being met by the proposed project:

- General Criteria for Granting Certificates of Appropriateness: 4 of 4 relevant criteria fully or partially satisfied.
- o Additional Guidelines for Alterations: 6 of 7 relevant criteria fully or partially satisfied.
- Additional Guidelines for New Construction: 6 or 7 criteria satisfied or generally satisfied by proposed windows installed with Conditions of Approval as recommended by Staff.

Summary of Findings, Ad Valorem Tax Exemption Review

The exterior aspects of the proposed project generally satisfy the COA criteria, which are closely related to the Secretary of the Interior's Standards for Rehabilitation of Historic Properties. Qualifying interior improvements mainly include upgrades to plumbing, electrical, and HVAC systems, which will extend the subject property's useful lifespan without diminishing historic integrity or removing/concealing character defining features.

Staff Recommendation

Based on a determination of general consistency with Chapter 16, City Code of Ordinances, staff recommends that the Community Planning and Preservation Commission **approve with conditions** the Certificate of Appropriateness (City File 21-90200045) and Ad Valorem Tax Exemption (City File 21-90400004) requests for the rehabilitation of the property at 217 10th Ave NE, a contributing property to the 200 Block of 10th Avenue Northeast Local Historic District, subject to the following:

- 1. Windows will be installed to be setback within the wall plane and feature a reveal of at approximately two to three inches to provide consistency with the historic windows at subject property.
- 2. Proposed windows will replicate traditional design and configuration, including four and fiveover-one sash windows throughout majority of primary residence as well as seven-over-one irregular sash windows at the façade in the reopened front porch.
- 3. Historic window trim will be reinstalled or closely replicated.
- 4. All other necessary permits shall be obtained. Any additional work shall be presented to staff for determination of the necessity of additional COA approval.
- 5. These approvals will be valid for 24 months from the date of this hearing, June 8, 2023.

Appendix A:

Application No. 21-90200045



CERTIFICATE OF APPROPRIATENESS

APPLICATION

All applications are to be filled out completely and correctly. The application shall be submitted to the City of St. Petersburg's Planning and Development Services Department, located on the 8th floor of the Municipal Services Building, One Fourth Street North, St. Petersburg, Florida. Laura Duvekot, Historic Preservationist II, (727) 892-5451 or Laura.Duvekot@stpete.org

GENERAL INFORMATION 217 10 Ave NE 18-31-17-05274-008-0090 **Property Address** Parcel Identification No. **Old North East** n/a Historic District / Landmark Name Corresponding Permit Nos. 860-999-4381 Michael Hussey Owner's Name Property Owner's Daytime Phone N 855 Cantral Ave. #310 St. Petersburg, FL. 33701 garfieldst47@yahoo.com Owner's Address, City, State, Zip Code Owner's Email Andrej Klobucar, Contractor, Konstrukt Builders, Inc. 727-459-7518 Authorized Representative (Name & Title), if applicable Representative's Daytime Phone No 855 37 Ave N St. Petersburg, FL. 33704 konstruktbuilders@gmail.com Representative's Address, City, State, Zip Code Representative's Email

APPLICATION '	TYPE (Check applicable)
Addition		Window Replacement
New Construction		Door Replacement
Demolition		Roof Replacement
Relocation	•	Mechanical (e.g. solar)
Other:		

	TYPE OF WORK (Check applicable)
	Repair Only
•	In-Kind Replacement fence HVAC
•	New Installation Pool
	Other:

AUTHORIZATION

By signing this application, the applicant affirms that all information contained within this application packet has been read and that the information on this application represents an accurate description of the proposed work. The applicant certifies that the project described in this application, as detailed by the plans and specifications enclosed, will be constructed in exact accordance with aforesaid plans and specifications. Further, the applicant agrees to conform to all conditions of approval. It is understood that approval of this application by the Community Planning and Preservation Commission in no way constitutes approval of a building permit or other required City permit approvals. Filing an application does not guarantee approval.

- NOTES: 1) It is incumbent upon the applicant to submit correct information. Any misleading, deceptive, incomplete or incorrect information may invalidate your approval.
 - 2) To accept an agent's signature, a notarized letter of authorization from the property owner must accompany the application.

Signature of Owner:	Date:	4/8/21
Signature of Representative:	Date:	4/8/21

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CERTIFICATE OF APPROPRIATENESS

APPLICATION


COA#

All applications are to be filled out completely and correctly. The application shall be submitted to the City of St. Petersburg's Planning and Development Services Department by emailing directly to Historic Preservationists Laura Duvekot (<u>Laura.Duvekot@stpete.org</u>) or Kelly Perkins (<u>Kelly.Perkins@stpete.org</u>).

PROPOSED SCOPE OF WORK

Please provide a detailed description of the proposed work, organized according to the COA Matrix. Include information such as materials, location, square footage, etc. as applicable. Attach supplementary material as peeded

information such as mat	terials, location	on, square footage, etc. as applicable. Attach supplementary material as needed.
Building or Site Feature	Photo No.	Proposed Work
Swimming pool	see sketch	Add new inground swimming pool and equipment
Remove windows	3	Remove non historic windows in enclosed porch. Bring back front wrap around porch to original form.
Hvac equipment	see plans	Relocate and replace 2 new AC condensers to the west side of house
Fence		Install 6' white vinyl 2x2 picket fence, gate and arch near front of house.
Fence		Install 6' solid white vinyl fence and gate at west and alley side to match existing east side fence.
2 Laurel oak tree remaovel		Remove 1 laural oak beside garage apt. to close and full of decay. One at NE corner at end of its life.

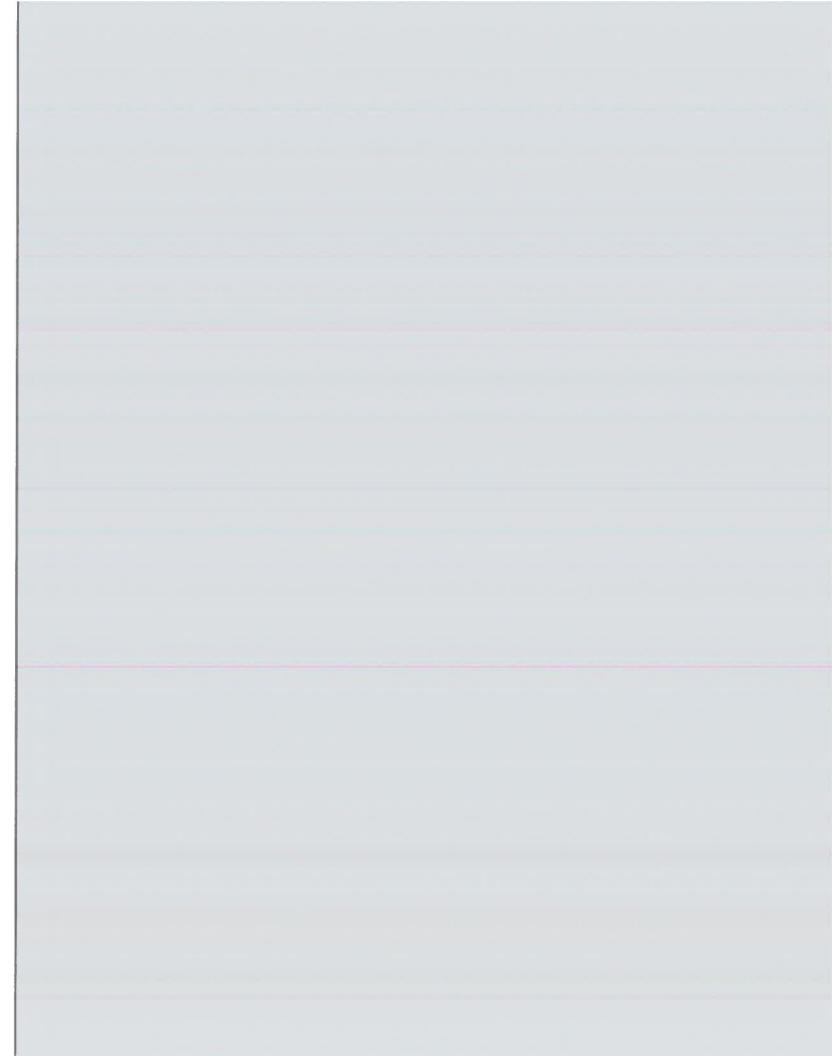



CERTIFICATE OF APPROPRIATENESS

APPLICATION

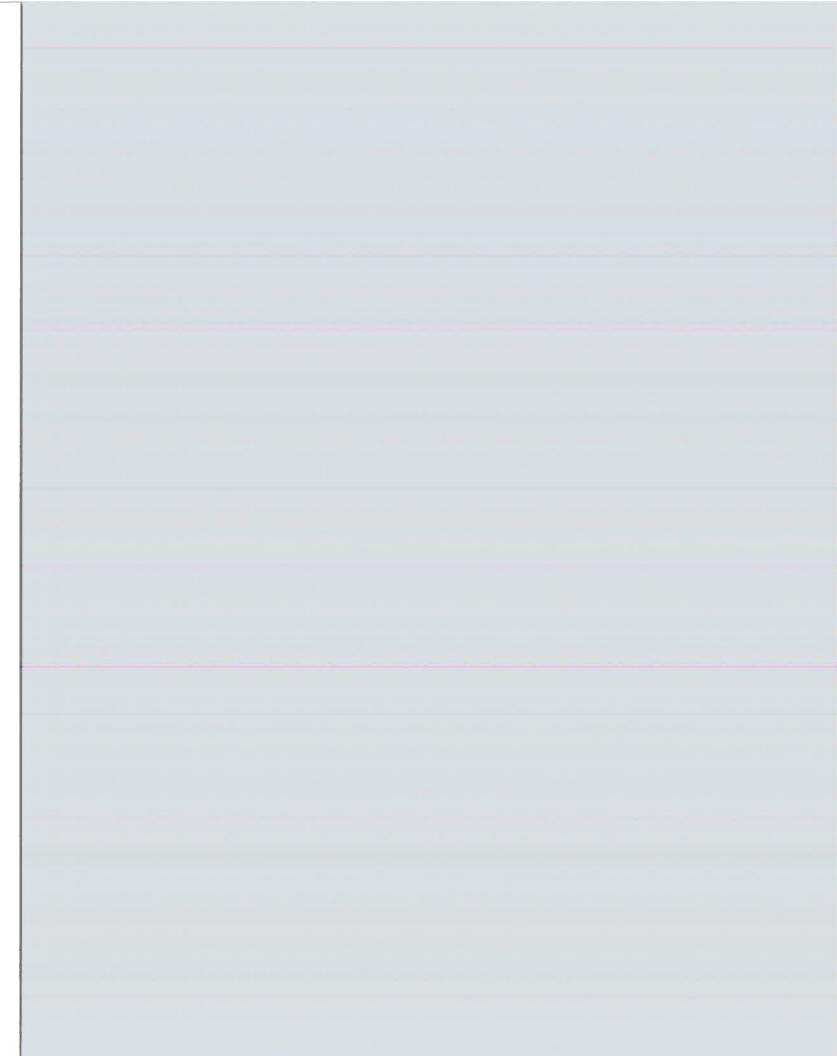
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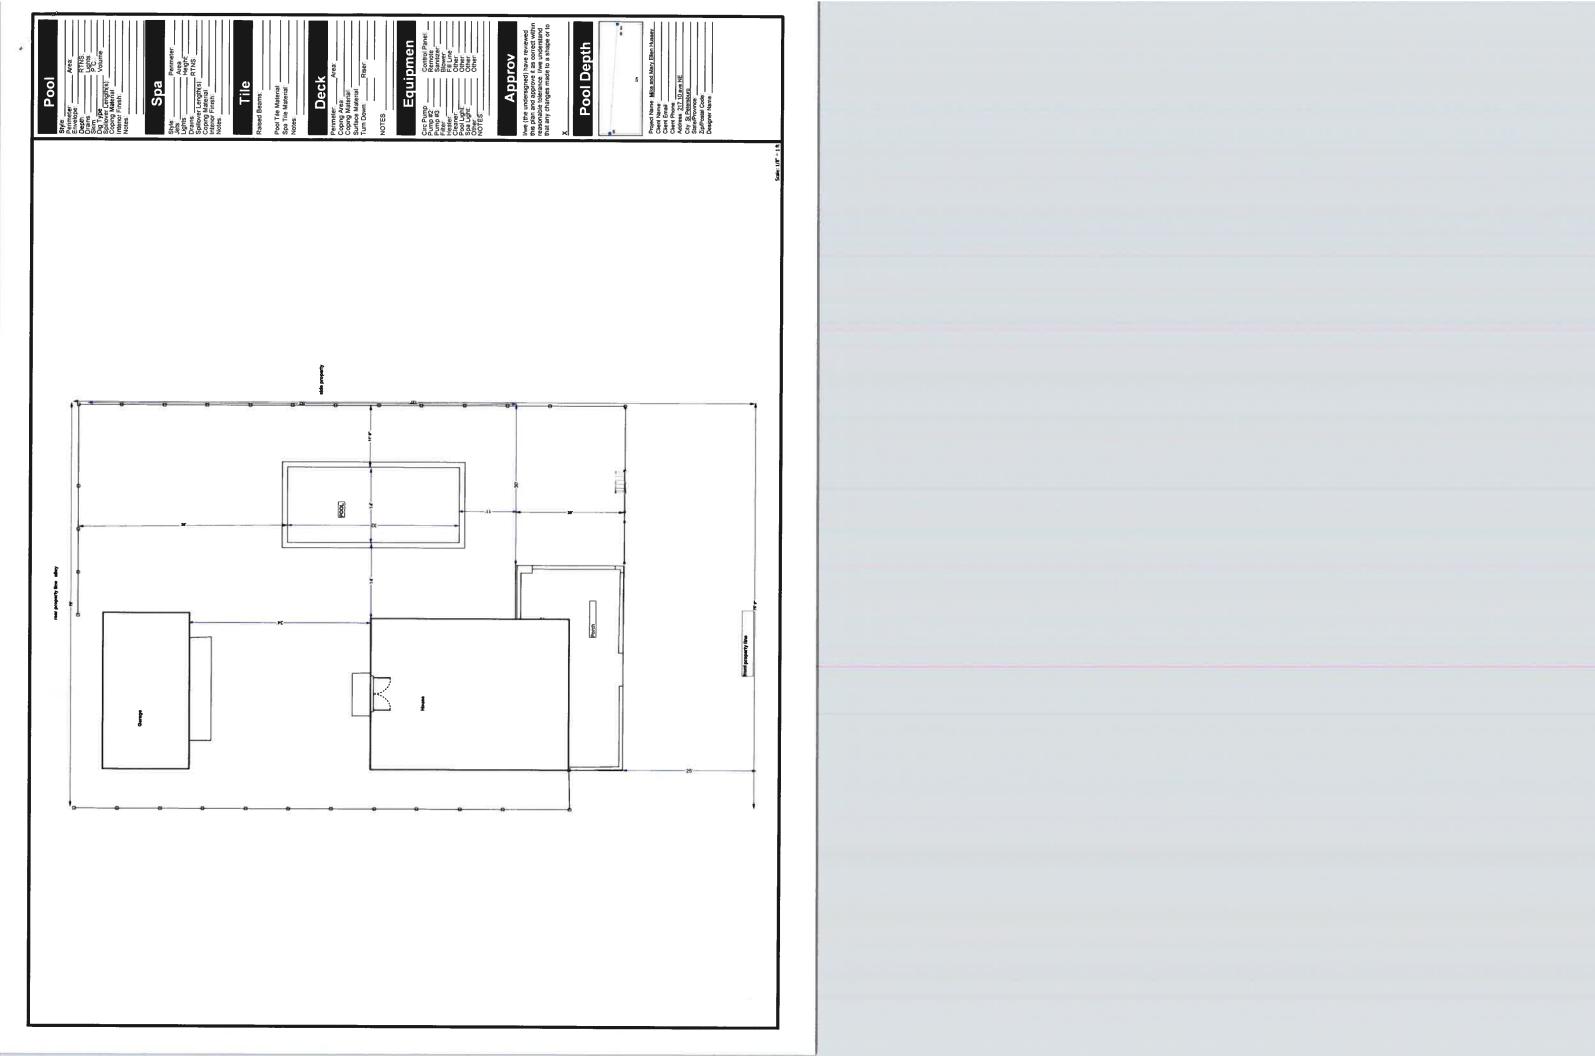
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PROPOSED SCOPE OF WORK

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Building or Site Feature	Photo No.	Proposed Work
Replace Windows	1	Replace all windows with matching existing style, vinyl, impact rated glass.
Eliminate 3 window openings	2	Remodel laundry room, remove 2 west side windowsand 1 north side window. Cover exterior with mathching lap siding











SINGLE HUNG - LARGE MISSILE IMPACT (SHOWN WIDIFFERENT OPTIONS)




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LARGE MISSILE IMPACT IMPACT RATING MAX. UNIT DESIGN PRESSURE SIZE RATING 53-1/8" x 76" +/- 50 PSF 53-1/8" x 76"

THE PRODUCT SHOWN HEREIN IS DESIGNED AND MANUFACTURED TO COMPLY WITH THE FLORIDA BUILDING CODE (FBC), CURRENT EDITION AND IS RATED FOR MISSILE LEVEL D IMPACT USE IN WIND ZONE 3 AREAS AS DEFINED IN ASTM E 1996 PER THE FBC.

WINDOW SYSTEMS 1900 SWATH AVE COLAR, FLORIDA 34474

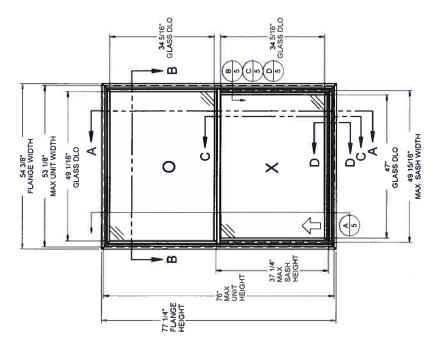THIS PRODUCT MAY NOT BE USED IN THE HIGH VELOCITY HURRICANE ZONE (HVHZ) OR IN ASTM E 1996 WIND ZONE 4 AREAS.

GLAZING OPTIONS (SEE SHEET 2) CONFIGURATIONS "O/X"

6100 PVC SINGLE HUNG IMPACT

- 4. DESIGN PRESSURE RATING:
 -NEGATIVE DESIGN LOADS BASED ON, TESTED PRESSURE AND
 GLASS TABLES ASTIM E-1300-04e01/09.
 -POSITIVE DESIGN LOADS BASED ON, TESTED PRESSURE, WATER
 INFILTRATION TEST PRESSURE AND GLASS TABLES
 ASTIM E-1300-04e01/09.
- ANCHORAGE: THE 33 1/3% STRESS INCREASE HAS NOT BEEN USED IN THE DESIGN OF THIS PRODUCT. SEE SHEET'S FOR ANCHOR DETAILS. WINDLOAD DURATION FACTOR Cd=1,6 WAS USED FOR WOOD ANCHOR CALCULATIONS.
 - 6. PRODUCT APPROVED FOR IMPACT RESISTANCE. SHUTTERS ARE NOT REQUIRED.
- ALL FRAMES AND VENTS FULLY WELDED. SMALL JOINT SEAM SEALANT USED AT FIXED MEETING RAIL AND JAMB.

SERIES / MODEL DESIGNATION SH-6100

 SECTION CALLOUTS APPLY TO ALL ELEVATIONS IN A SIMILAR LOCATION. 9. THE DESIGNATION X AND O STAND FOR THE FOLLOWIY X = OPERABLE SASH, O = FIXED SASH

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7/23/2020

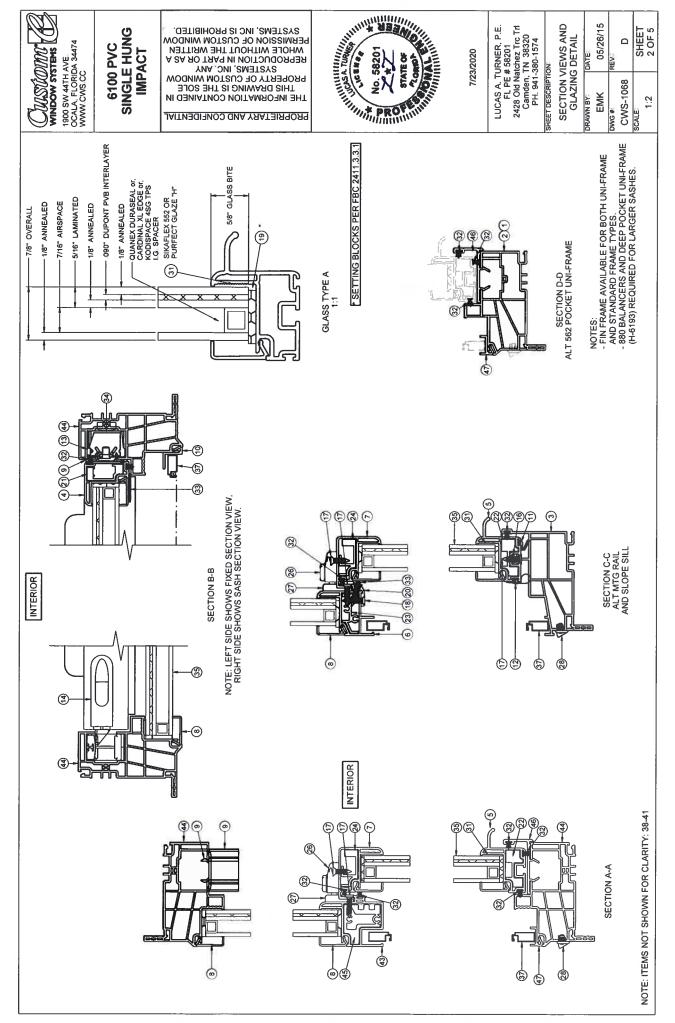
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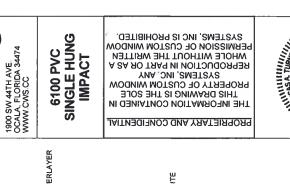
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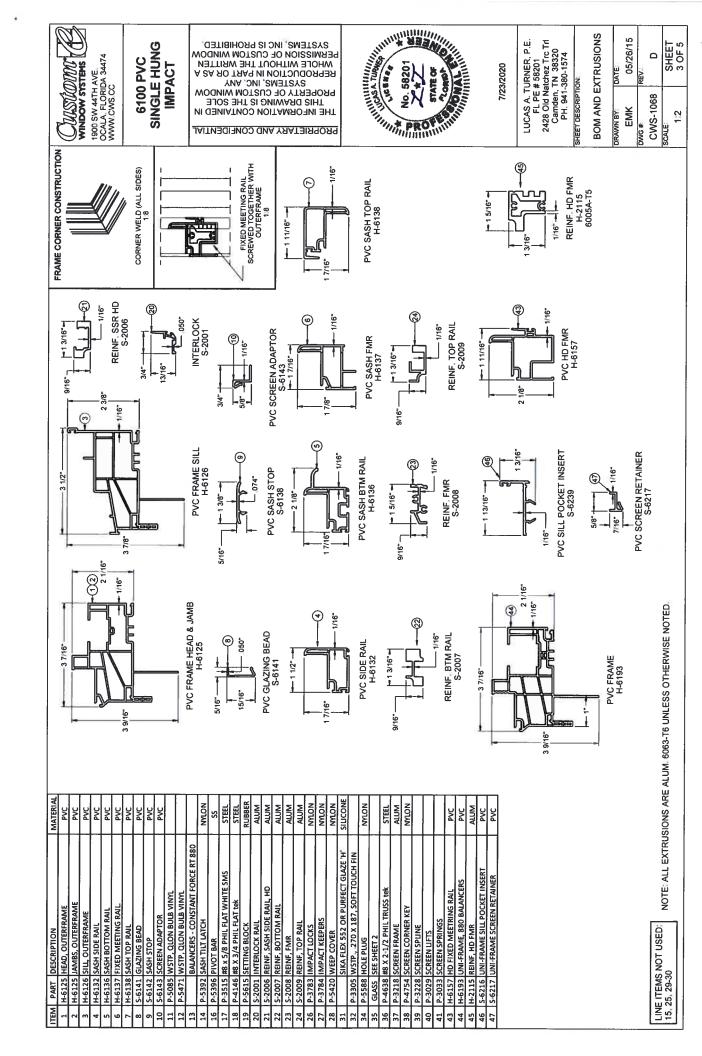
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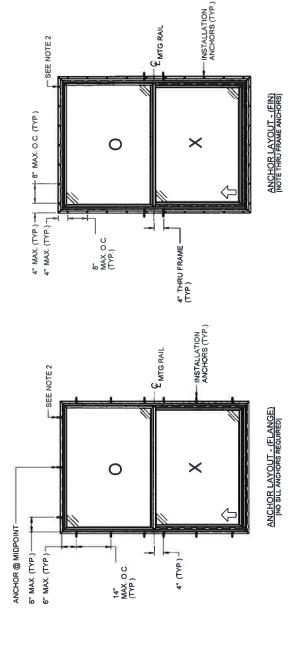
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6100 PVC SINGLE HUNG IMPACT

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8. WOOD OR MASONRY OPENINGS, BUCKS AND BUCK FASTENERS SHALL BE PROPERLY DESIGNED BY THE ARCHITECT OR ENGINEER OF RECORD AND INSTALLED TO TRANSFER WIND LOADS TO THE STRUCTURE.
SUBSTRATES SHALL MEET THE MINIMUM STRENGTH REQUIREMENTS AS SHOWN IN TABLE1, SHEET 5. CONCRETE AND MASONRY SUBSTRATES MAY NOT BE CRACKED.

9. SEALING AND FLASHING STRATEGIES FOR OVERALL WATER RESISTANCE OF INSTALLATION SHALL BE DONE BY OTHERS FOLLOWING THE CURRENT VERSION OF THE REFERENCE DOCUMENTS. FMAJAAMA 100(FIN WINDOWS), FMAJAAMA 100(FIN WIND

ANCHOR EMBEDMENT TO SUBSTRATE SHALL BE BEYOND WALL DRESSING OR STUCCO. FOR CONCRETE/CMU OPENINGS, EMBEDMENT SHALL BE BEYOND WOOD BUCKS, IF USED, INTO SUBSTRATE. INSTALLATIONS INTO SOLID CONCRETE OR GROUT-FILLED CMU MAY INCLUDE BUT DO NOT REQUIRE 1X WOOD BUCKS BETWEEN THE PRODUCT AND SUBSTRATE. INSTALLATIONS INTO HOLLOW CMU REQUIRE THE USE OF 1X WOOD BUCKS BETWEEN THE PRODUCT AND SUBSTRATE.

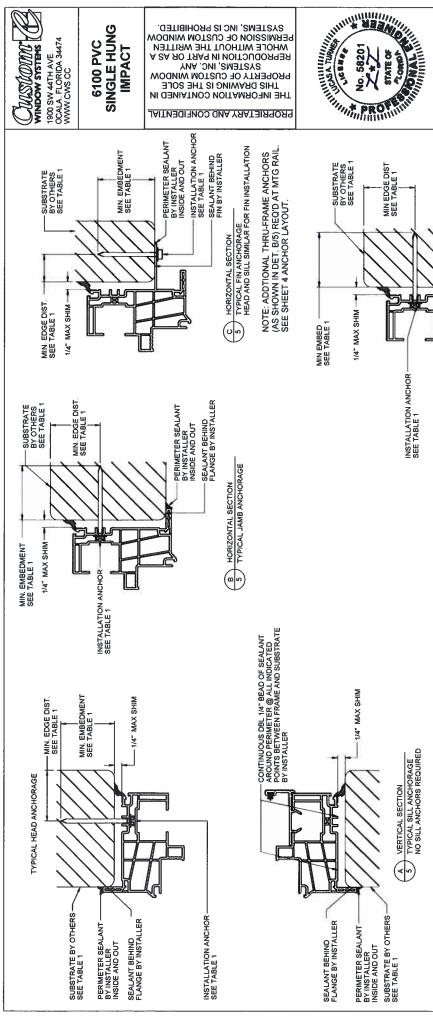
4. ALL INSTALLATION ANCHORS MUST BE MADE OF OR PROTECTED WITH A CORROSION RESISTANT MATERIAL OR COATING. DISSIMILAR BE PROTECTED TO PREVENT REACTION.

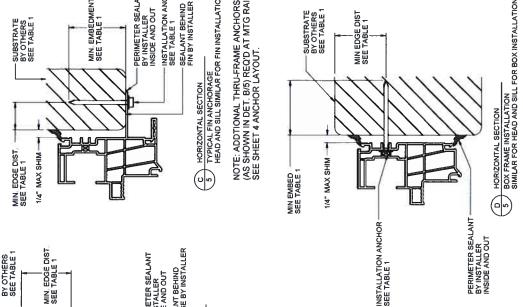
2. SHIM AS REQ AT EACH INSTALLATION ANCHOR USING LOAD BEARING SHIMS. MAX. ALLOWABLE SHIM STACK TO BE 1/4". CONSTRUCTED OF HIGH DENSITY PLASTIC OR BETTER. WOOD SHIMS ARE NOT ALLOWED. 3. ANCHOR TYPE, SIZE, SPACING AND EMBEDMENT SHALL BE AS SPECIFIED IN THESE DRAWINGS, SEE TABLE 1, SHEET 5

INSTALL ONE ANCHOR AT EACH INSTALLATION LOCATION

5. INSTALLATION ANCHORS SHALL BE IN ACCORDANCE WITH ANCHOR MANUFACTURER'S INSTALLATION INSTRUCTIONS, AND ANCH SPECIFIED IN TABLE 1, SHEET 5.

7. A MINIMUM CENTER-TO-CENTER SPACING SHALL BE MAINTAINED BETWEEN ALL FASTENERS: 3-9/16" FOR MASONRY, 1" FOR WOOD AND METAL





FLANGE REMOVAL NOTE: PARTIALLY OR FULLY REMOVING THE FLANGE,
UP TO AND INCLUDING A BOX-FRAME APPLICATION IS ACCEPTABLE PROVIDED:
- MIN. 1/4" FILLET OF CONSTRUCTION-GRADE ADHESIVE CAULK IS APPLIED
INSIDE AND OUT, FULL PERIMETER, BY INSTALLER.
- PRODUCT ANCHORAGE IS IN ACCORDANCE WITH REQUIREMENTS AS
SHOWN FOR ELANGE WINDOWS

7/8"

FLANGE 2X MIN. SOUTHERN PINE (G=0.55)
FLANGE 16 GAUGE (0.060") MIN. STEEL STUD
FLANGE (33 KSI YIELD MIN.)
FLANGE 1/8" ALUM. (6063-15 MIN.) OR
1/8" ALUM. (6063-15 MIN.)
FIN 2X MIN. SOUTHERN PINE (G=0.55)
NOTE: UNIF-FRAME OPTIONS NOT SHOWN.

TABLE 1: APPROVED INSTALLATION FASTER

THE INFORMATION CONTAINED IN THIS DRAWING IS THE SOLE PROPERTY OF CUSTOM WINDOW SYSTEMS, INC. ANY MOLE WITHOUT THE WRITTEN WINDOW OF CUSTOM WINDOW SYSTEMS, INC IS PROHIBITED. 6100 PVC SINGLE HUNG IMPACT

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EXISTING REAR ELEVATION SCALE: 1/4" = 1'-0"



EXISTING LEFTSIDE ELEVATION SCALE: 1/4" = 1'-0"

PRELIMENARY PLAN SET NOT FOR PERMIT

Hussy Remodel
217 - 10th Avenue N.E.
St. Petersburg, Florida Aesigns Street

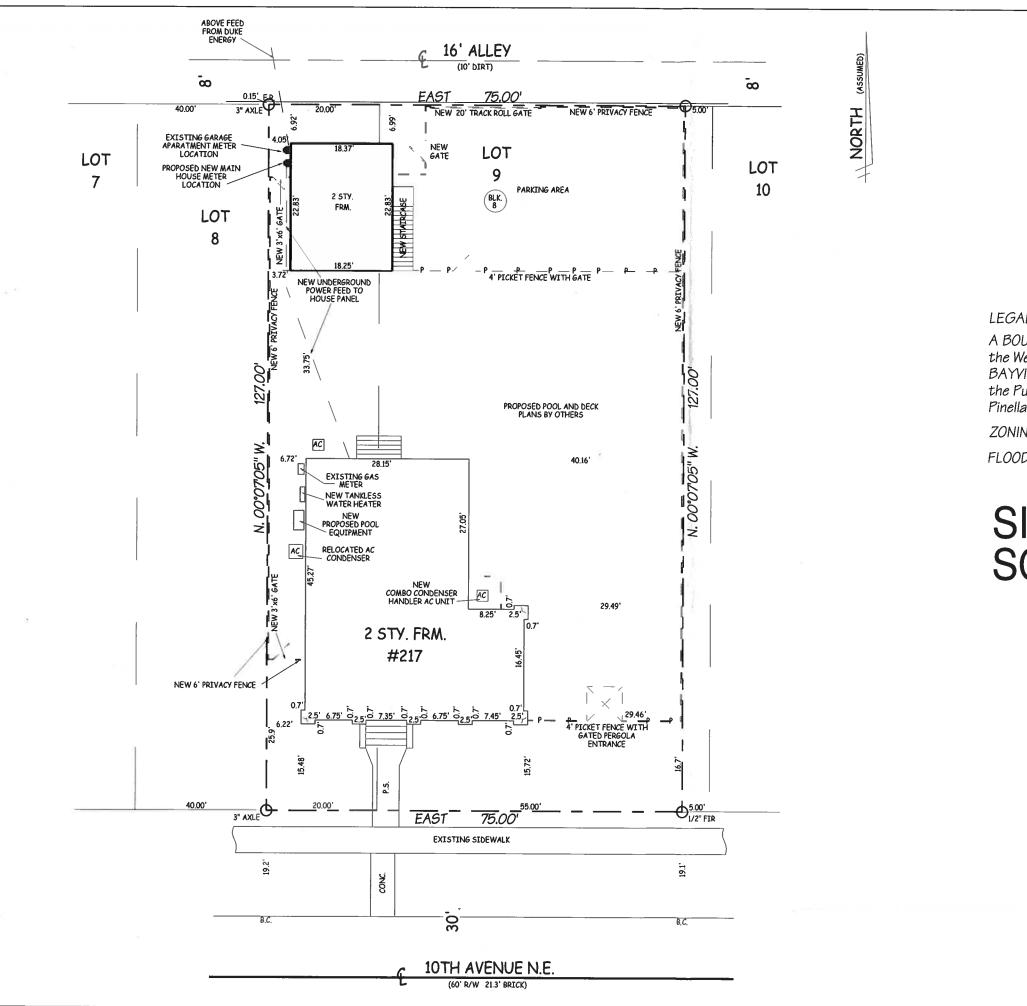
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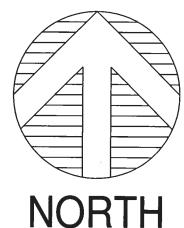
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THESE DESIGNS AND DRAWINGS ARE THE COPYRIGHTED PROPERTY OF BAKER STREET DESIGNS AND MAY NOT BE REPRODUCED EXCEPT WITH SPECIFIC WRITTEN CONSENT OF THE DESIGNER. THE CONTRACTOR MUST CHECK AND VERIFY ALL DIMENSIONS OF THE JOB AND BE RESPONSIBLE FOR SAME. REPORTING ANY DISCREPANCIES TO THE DESIGNER BEFORE COMMENCING WORK,



LEGAL DESCRIPTION

A BOUNDARY SURVEY OF: The East 20.00 feet of Lot 8 and the West 55.00 feet of Lot 9, Block 8, SNELL & HAMLETT'S BAYVIEW ADDITION, as recorded in Plat Book 6, Page 11 of the Public Records of Hillsborough County, Florida, of which Pinellas County was formerly a part.

ZONING: ???

FLOOD ZONE: ?

SITE PLAN SCALE: 1/8" = 1'-0"

BUILDERS

St. Petersburg,

KONSTRUCT E (727) 450-7518 855 - 37th Ave. N., St. Pete

Hussy Remodel 217 - 10th Avenue N.E. St. Petersburg, Florida

Aesigns

Maker Street Jesser Jesse Jesse



Petersburg,

KONSTRUCT E (727) 450-7518 855 - 37th Ave. N., St. Peter

Hussy Remode 217 - 10th Avenue N.E. St. Petersburg, Florida

Aesigns

Street

Maker (14227 Puffin Court

AM

BUILDERS, INC

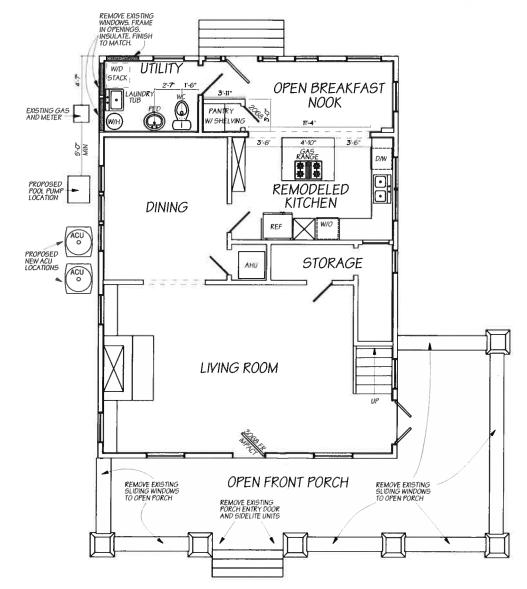
(XX)

PROPOSED REAR ELEVATION SCALE: 1/4" = 1'-0"




PROPOSED LEFTSIDE ELEVATION SCALE: 1/4" = 1'-0"

PRELIMENARY PLAN SET NOT FOR PERMIT




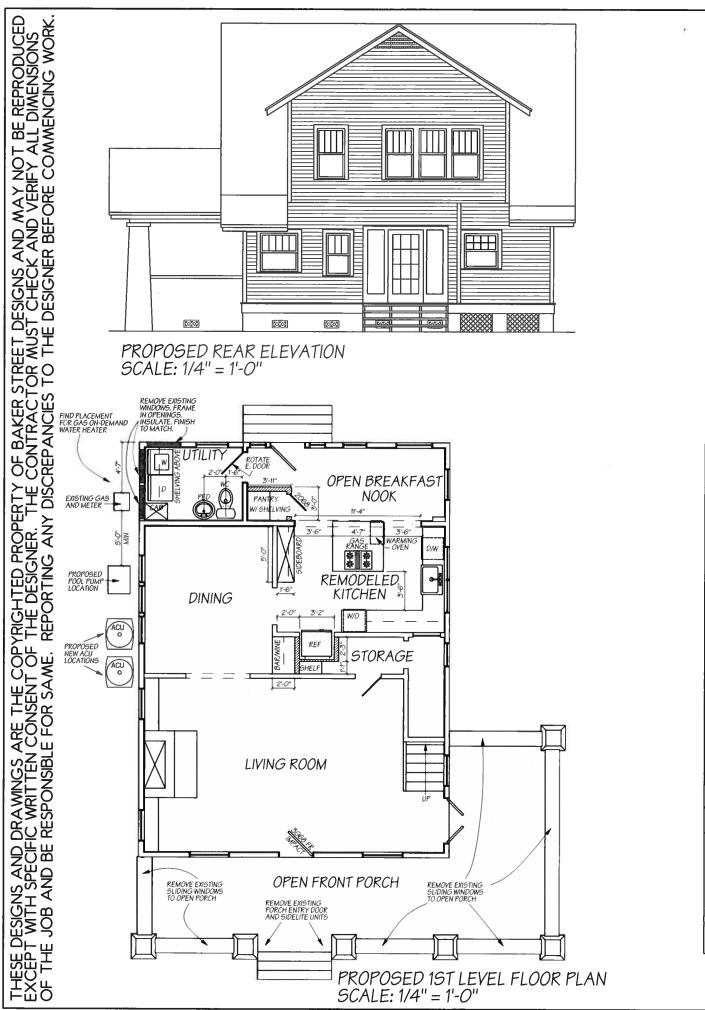PROPOSED 1ST LEVEL FLOOR PLAN SCALE: 1/4" = 1'-0"





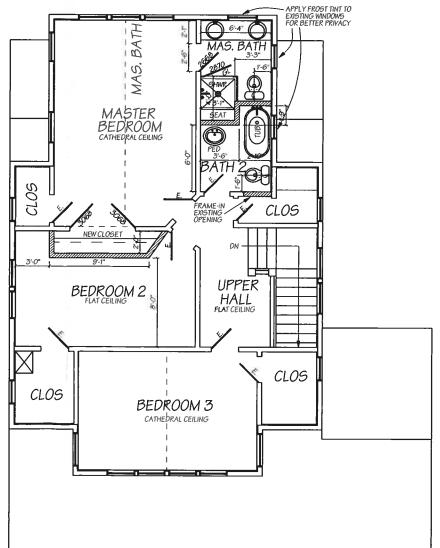PROPOSED LEFTSIDE ELEVATION SCALE: 1/4" = 1'-0"



EXISTING 2ND LEVEL FLOOR PLAN SCALE: 1/4" = 1'-0"

PRELIMENARY PLAN SET **NOT FOR PERMIT**

Hussy Remode 217 - 10th Avenue N.E. St. Petersburg, Florida Aesigns Maker Street 14227 Puffin Court Cleanwater, Florida 33762 (72

(727) 656-5

3

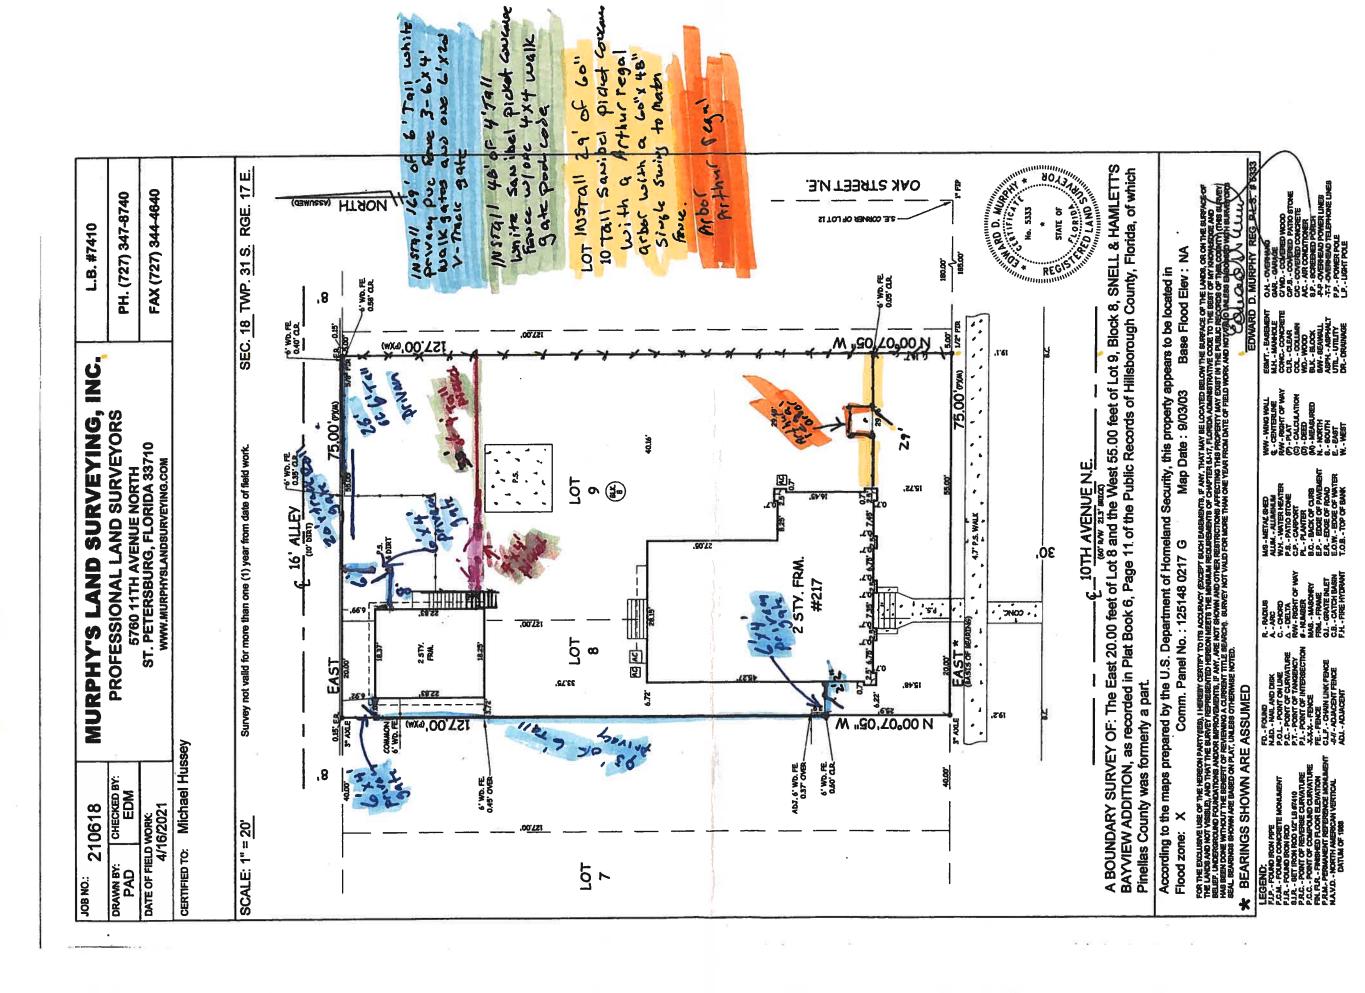
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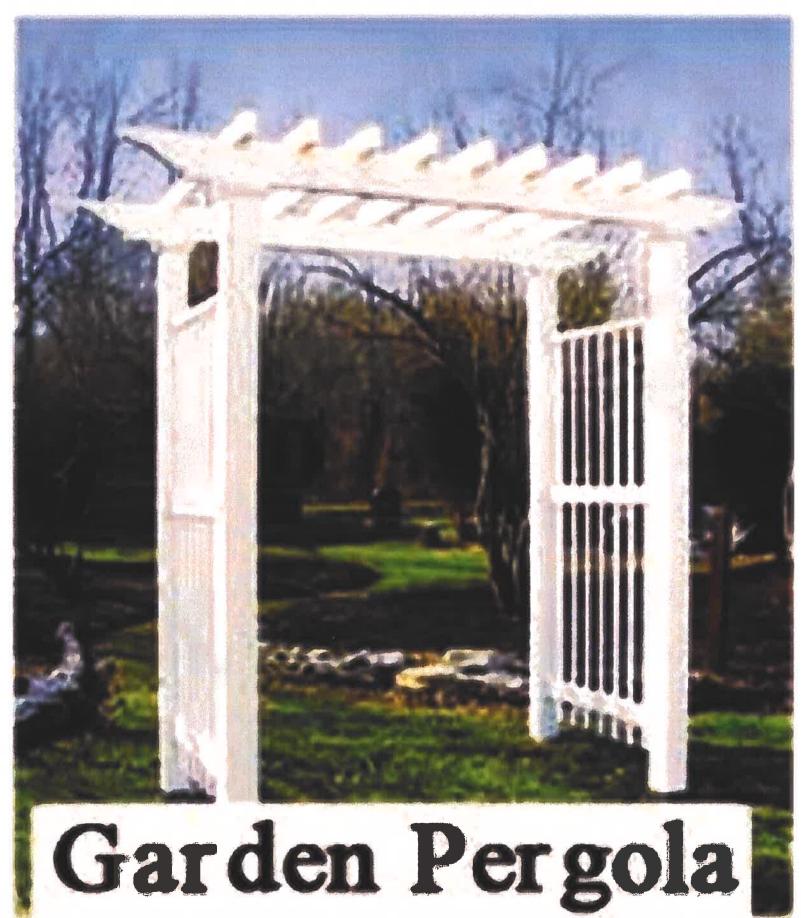
BUILDERS

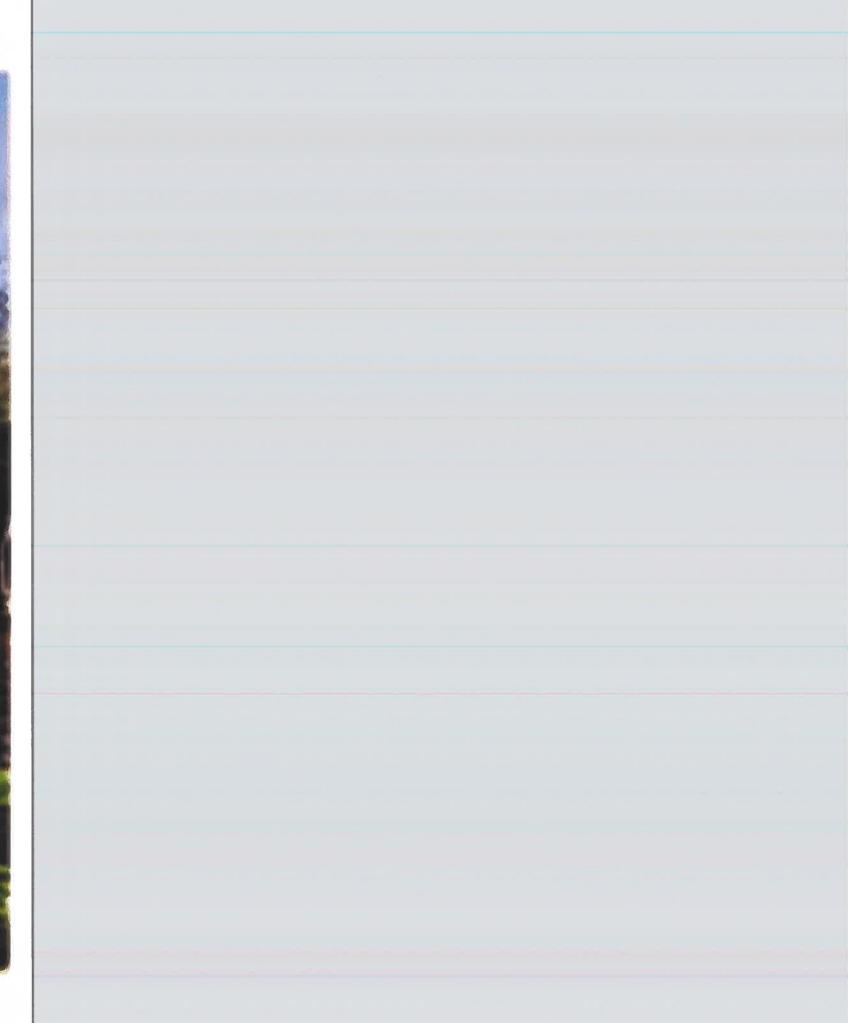
KONSTRUCT BUILE (727) 450-7518 855 - 37th Ave. N., St. Petersburg, FI

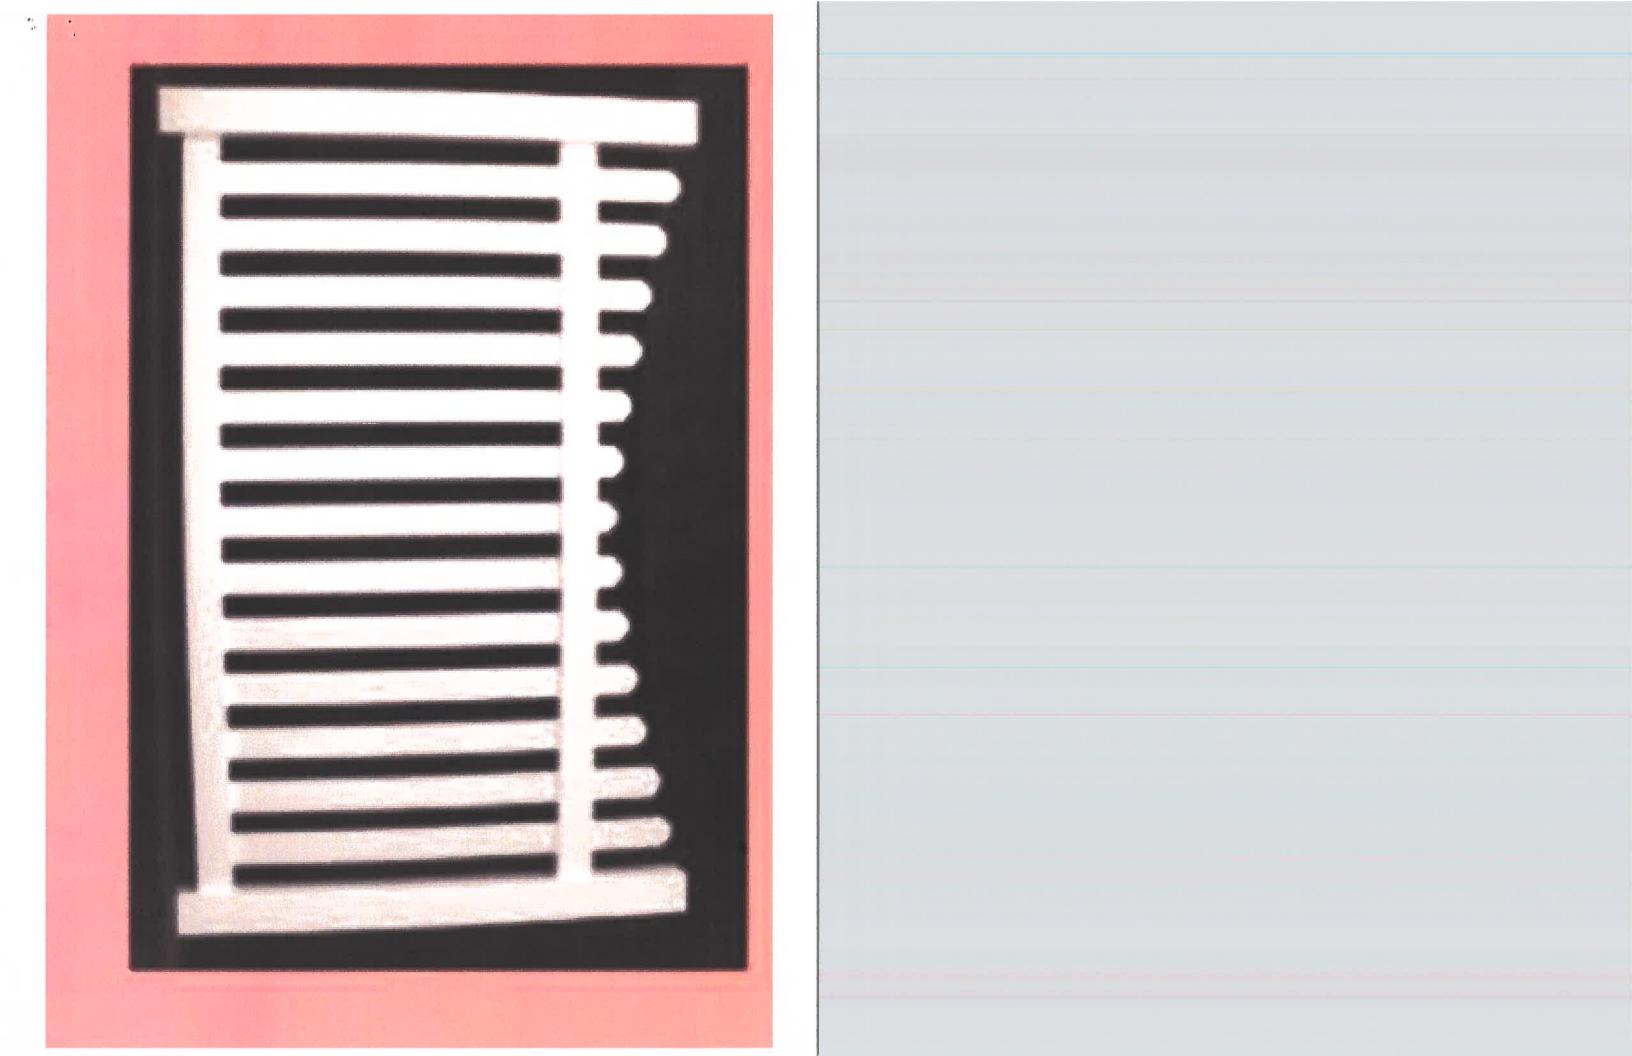
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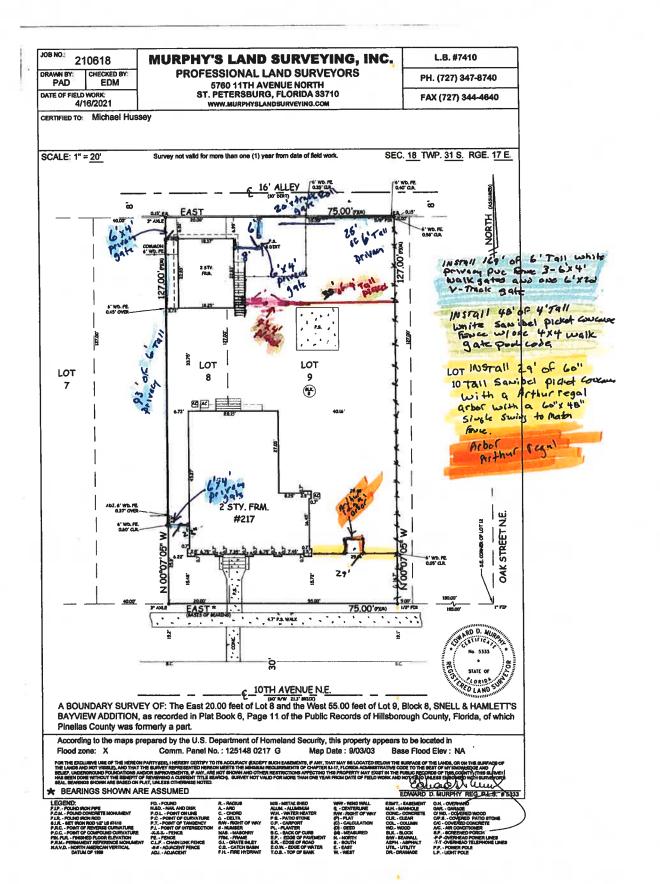


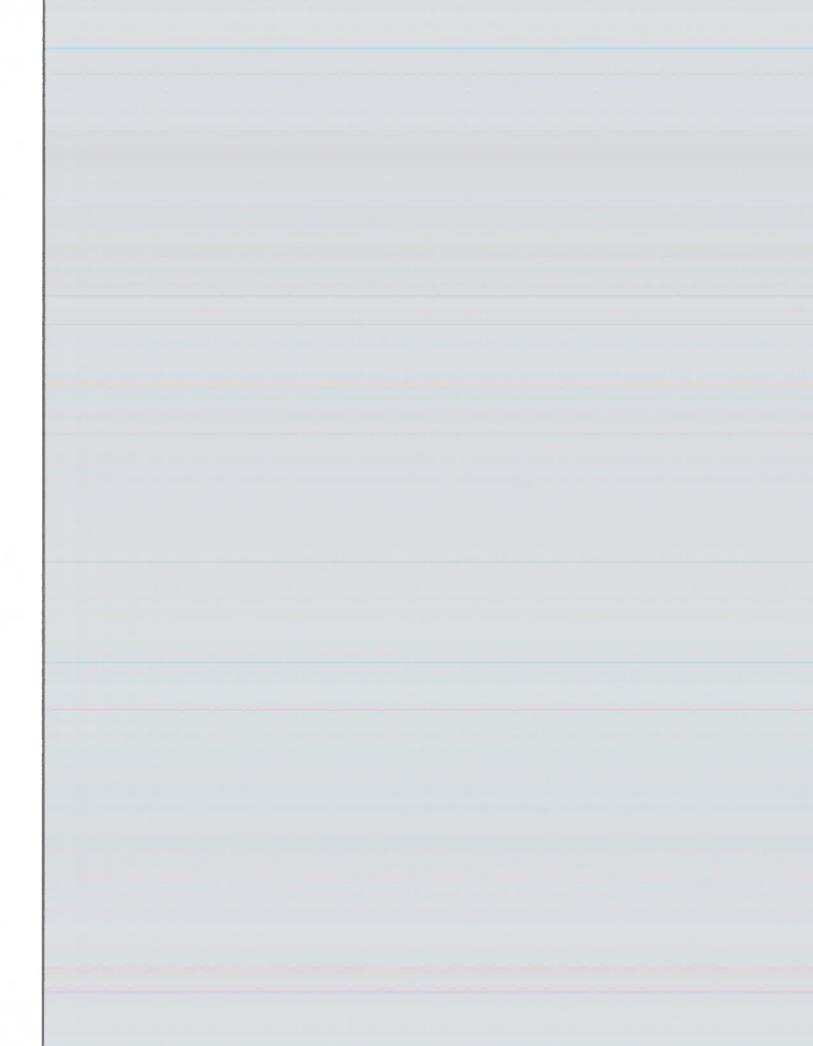
















PAGE 1 OF 6

CUSTOMER INFORMATION

CUSTOMER PO: Konstrukt - Hussey
JOB NAME Konstrukt - Konstrukt COMPANY NAME:BAY GLASS & WINDOWS

3150 39th Ave N ST.PETERSBURG, FL 33714

QUOTE

PREPARED BY brennen.bourgeois@bcsi-fl QUOTE NUMBER 25342
ESTIMATED SHIP 06/30/2021
DATE

LINE ITEM # 100-1 DESCRIPTION QTY PRICE EXTENDED

Exterior Fiberglass Entry Door

Standard

Unit Type and Dimensions:
Overall Size = 37.625 x 81.5
Frame Width = 37.625
Installation Type: Renovation
Unit Type: Pre-Hung
Unit Slab Size: Book Size

Weather Zone: Wind-Borne Debris Region - WBDR

Fire Rating: Not Rated

Door Swing: Inswing
Door Configuration: Left Hand

Nominal Width: 3'0"

Nominal Width: 3'0"
Nominal Height: 6'8"

Design Options:

Material: Smooth-Star

Panel Design: Craftsman Lite 2 Panel Shaker

Cut Down: Yes Height Cutdown: 0.5 Width Cutdown: 0 Glass Size: 21x15 Glass Type: Clear Glass Grille Style: None

Internal Grille Color: None Glass Style: Clear

Caming Option: None

Low-E: Yes

Add SDL to Glass:Yes

SDL Pattern:Craftsman 4 Lite

SDL Bar Width:7/8" Smooth Contoured

Sidelites and Transoms:

Wrapping:

Jamb Material: Composite Smooth White Frame

Jamb Size: 4 9/16 Exterior Trim: No Trim

Exterior Trim Material: Composite

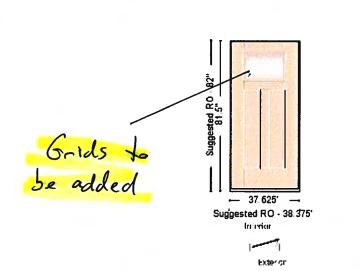
Interior Casing: None

Sill Type: Composite Adjustable

Send Trim Loose: Yes

Sidelite Sill: Composite Adjustable

Sill Finish: Mill Sill Cover: No





PAGE 2 OF 6

CUSTOMER INFORMATION

CUSTOMER PO: Konstrukt - Hussey

JOB NAME Konstrukt - Konstrukt
COMPANY NAME:BAY GLASS & WINDOWS

3150 39th Ave N

3150 39th Ave N ST.PETERSBURG, FL 33714

Sill Pan: No Knocked Down: No

Finishing:

Door Finish Type: Unfinished Exterior Trim & Jamb Finish: Unfinished Interior Trim & Jamb Finish: Unfinished

Hardware and Accessories:

Hinge Color: Stainless Steel

Hinge Type: Self-Aligning Ball-Bearing

Bore: Double Bore

Add Lockset Hardware: No

Backset: 2 3/8

Deadbolt Strike Prep: 9206 Standard

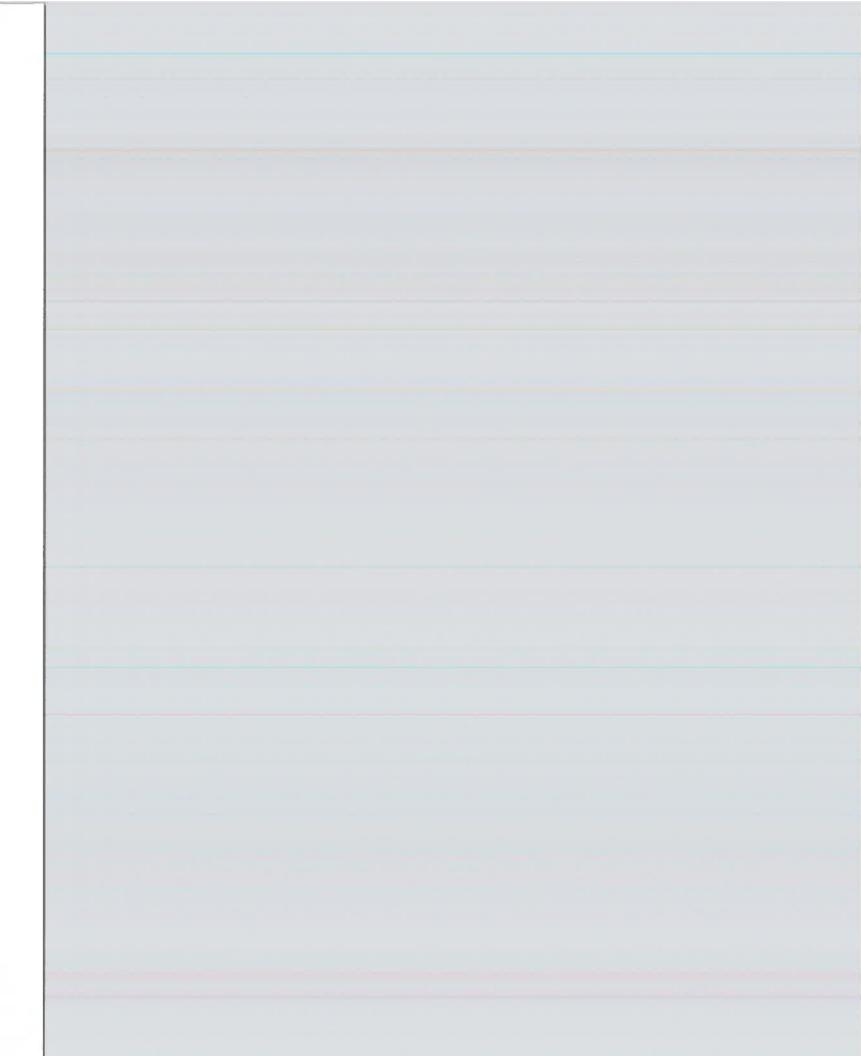
Screw Cover: No
Dentil Shelf: No
Peep Site: No
Security Strike: No
Security Strike Qty: 1
Weather Strip Color: Bronze

Rain Deflector: No

Dunnane Door: No

QUOTE

PREPARED BY brennen.bourgeois@bcsi-fl
QUOTE NUMBER 25342
ESTIMATED SHIP 06/30/2021
DATE





PAGE 3 OF 6

CUSTOMER INFORMATION

CUSTOMER PO: Konstrukt - Hussey

JOB NAME Konstrukt - Konstrukt -

COMPANY NAME:BAY GLASS & WINDOWS

3150 39th Ave N ST.PETERSBURG, FL 33714

QUOTE

PREPARED BY brennen.bourgeois@bcsi-fl QUOTE NUMBER 25342
ESTIMATED SHIP 06/30/2021
DATE

LINE ITEM # 200-1 DESCRIPTION QTY PRICE EXTENDED

Exterior Fiberglass Double Entry Door Standard

Unit Type and Dimensions:
Overall Size = 62.5625 x 81.5
Frame Width = 62.5625
Installation Type: Renovation
Unit Type: Pre-Hung
Unit Slab Size: Book Size

Weather Zone: Wind-Borne Debris Region - WBDR

Fire Rating: Not Rated Door Swing: Inswing

Door Configuration: LH Active RH Inactive

Nominal Width: 5'0" Nominal Height: 6'8"

Design Options:

Material: Smooth-Star

Panel Design: Full Lite W/ No Stile Lines

Cut Down: Yes

Height Cutdown: 0.5 Width Cutdown: 0 Glass Size: 20x64

Glass Type: Clear Glass

Grille Style: None Internal Grille Color: None

Glass Style: Clear

Caming Option: None

Low-E: Yes
Add SDL to Glass:Yes

SDL Pattern:Custom Lite

SDL Bar Width:7/8" Smooth Contoured

Sidelites and Transoms:

Wrapping:

Jamb Material: Composite Smooth White Frame

Jamb Size: 4 9/16 Exterior Trim: No Trim

Exterior Trim Material: Composite

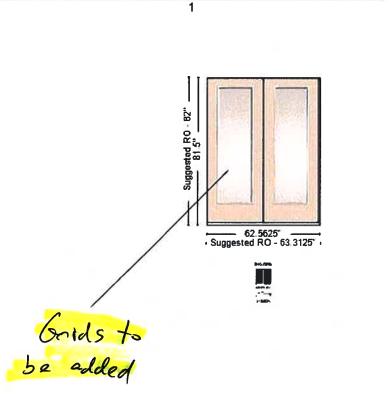
Interior Casing: None

Sill Type: Composite Adjustable

Send Trim Loose: Yes

Sidelite Sill: Composite Adjustable

Sill Finish: Mill Sill Cover: No





PAGE 4 OF 6

CUSTOMER INFORMATION

CUSTOMER PO: Konstrukt - Hussey JOB NAME Konstrukt - Konstrukt -**COMPANY NAME:**BAY GLASS & WINDOWS

3150 39th Ave N ST.PETERSBURG, FL 33714 **QUOTE**

PREPARED BY brennen.bourgeois@bcsi-fl **QUOTE NUMBER** 25342 ESTIMATED SHIP 06/30/2021 DATE

Sill Pan: No Knocked Down: No

Finishing:

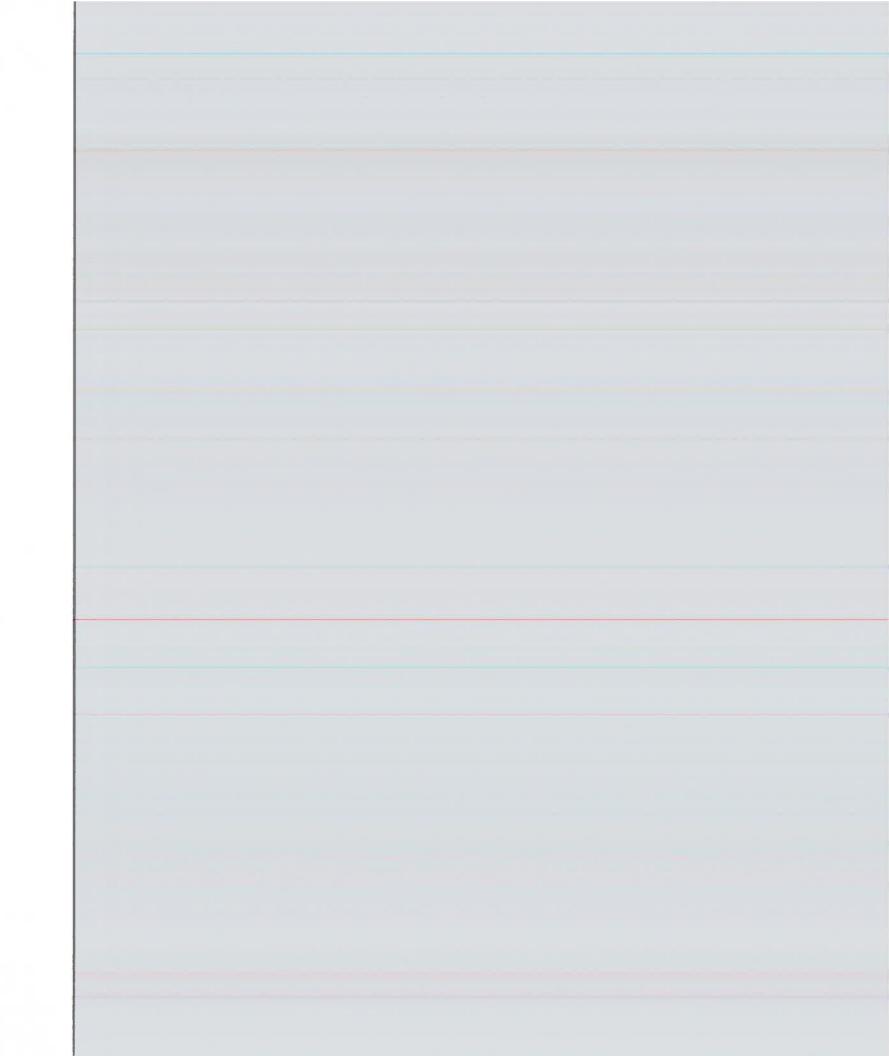
Door Finish Type: Unfinished Exterior Trim & Jamb Finish: Unfinished Interior Trim & Jamb Finish: Unfinished

Hardware and Accessories : Hinge Color: Stainless Steel Hinge Type: Self-Aligning Ball-Bearing Bore: Double Bore Inactive Bore: No Bore Handleset for Inactive Door: No Add Lockset Hardware: No Backset: 2 3/8

Deadbolt Strike Prep: 9206 Standard

Screw Cover: No Dentil Shelf: No Peep Site: No Security Strike: No Weather Strip Color: Bronze

Rain Deflector: No.





PAGE 5 OF 6

CUSTOMER INFORMATION

CUSTOMER PO: Konstrukt - Hussey JOB NAME Konstrukt - Konstrukt -

COMPANY NAME:BAY GLASS & WINDOWS

3150 39th Ave N ST.PETERSBURG, FL 33714

QUOTE

PREPARED BY brennen.bourgeois@bcsi-fl **QUOTE NUMBER** 25342 ESTIMATED SHIP 06/30/2021 DATE

LINE ITEM # 300-1 DESCRIPTION QTY PRICE EXTENDED

Exterior Fiberglass Entry Door Double Sidelite

Unit Type and Dimensions:

Overall Size = 68.625 x 82

Unit 1, 3: Sidelite Frame Width = 15.5

Unit 2: Door Frame Width = 37.625

Installation Type: Renovation

Unit Type: Pre-Hung

Unit Slab Size: Book Size

Weather Zone: Wind-Borne Debris Region - WBDR

Fire Rating: Not Rated

Door Swing: Inswing

Door Configuration: Left Hand

Sidelite Swing: Fixed

Nominal Width: 3'0"

Nominal Height: 6'8"

Nominal Width - SL: 14"

Nominal Height - SL: 6'8"

Design Options:

Material: Smooth-Star

Panel Design: Full Lite W/ No Stile Lines Cut Down: No

Width Cutdown: 0

Glass Size: 22x64

Glass Type: Clear Glass

Grille Style: None

Internal Grille Color: None

Glass Style: Clear

Caming Option: None

Low-E: Yes

Add SDL to Glass:Yes

SDL Pattern:Custom Lite

SDL Bar Width:7/8" Smooth Contoured

Sidelites and Transoms:

Material - SL: Smooth-Star

Glass Layout - SL: 1/2 Lite

Panel Design - SL: Half Lite Sidelite 1 Panel

Glass Size - SL: 8x36

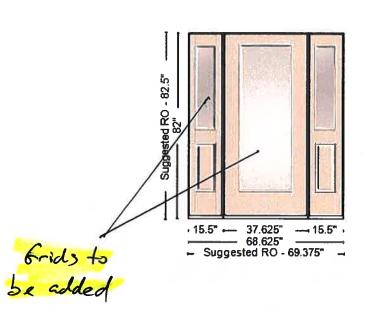
Glass Type - SL: Clear Glass

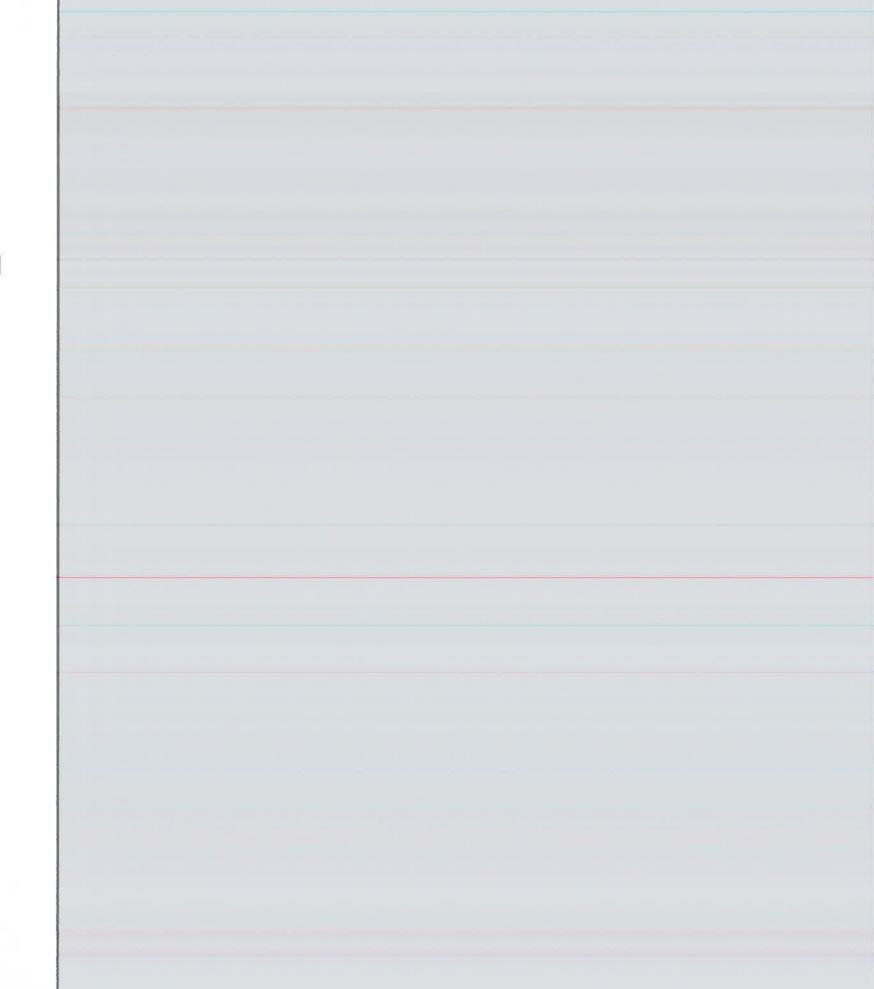
Grille Style - SL: None

Internal Grille Color - SL: None

Glass Style - SL: Clear

Caming Option - SL: None







PAGE 6 OF 6

CUSTOMER INFORMATION

CUSTOMER PO: Konstrukt - Hussey JOB NAME Konstrukt - Konstrukt -**COMPANY NAME:**BAY GLASS & WINDOWS

3150 39th Ave N ST.PETERSBURG, FL 33714 **QUOTE**

PREPARED BY brennen.bourgeois@bcsi-fl **QUOTE NUMBER** 25342 ESTIMATED SHIP 06/30/2021 DATE

Low-E - SL: Yes

Wrapping:

Jamb Material: Composite Smooth White Frame

Jamb Size: 4 9/16 Exterior Trim: No Trim Exterior Trim Material: Composite Interior Casing: None

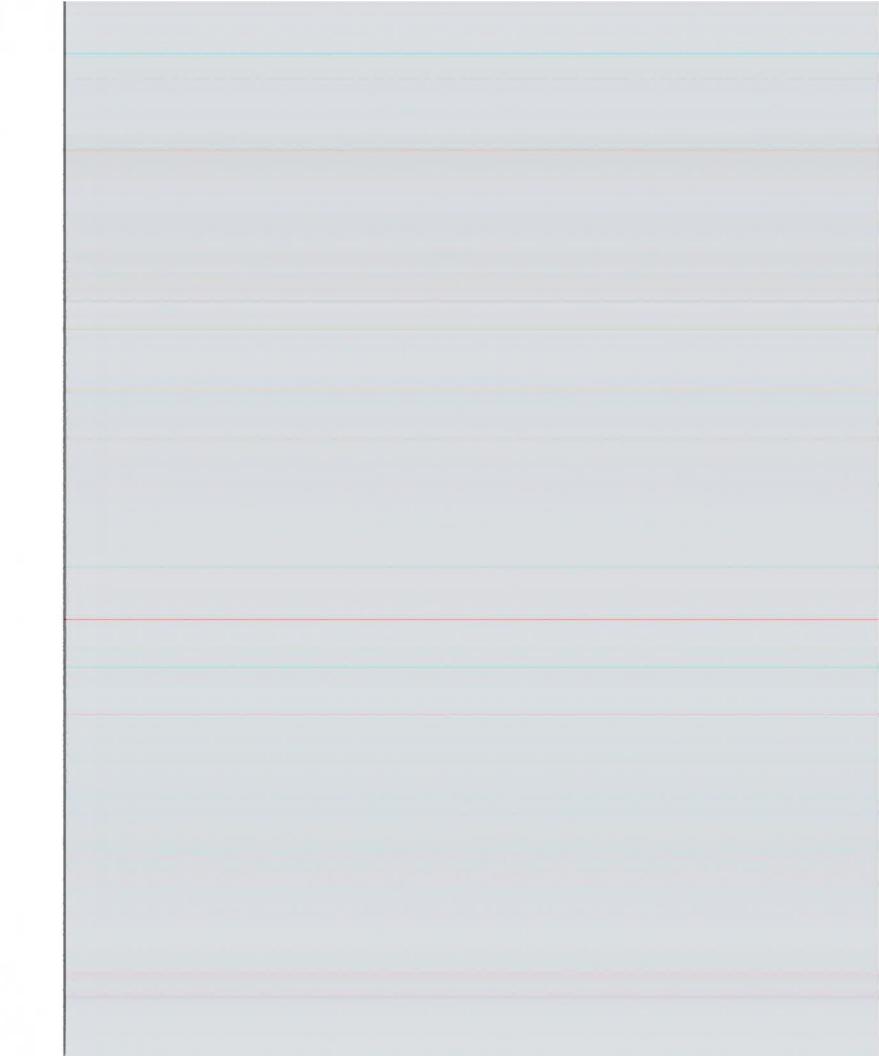
Interior Mull Casing: None Sill Type: Composite Adjustable

Send Trim Loose: Yes

Sidelite Sill: Composite Adjustable

Sill Finish: Mill Sill Cover: No Sill Pan: No Knocked Down: No

Finishing :
Door Finish Type: Unfinished
Touch-Up Kit: Yes Exterior Trim & Jamb Finish: Unfinished Interior Trim & Jamb Finish: Unfinished







By: Holly Vidas

Quote #: 2004610/1

1900 S.W. 44th Avenue. Ocala, FL 34474 Ph: 352-368-6922 Fax: 352-368-2928

BAY GLASS & WINDOW INC. Preferred Builder

Bill To:

Ship To:

SHIP TO

3150 39TH AVENUE NORTH
ST. PETERSBURG, FL 33714

ST. PETERSBURG, FL 33714

Ph: 727 525-3828

Route: StPet
Cust No. BAY101-P3620
Cust PO#: Konstruct - Hussey (Main House)

Item No. 1 Qty: 1

Ph: 727 525-3828

Model: 6100-SH Color: WHITE

Desc: Series 6100 Storm Strong Single Hung DP:+50/-50, [BOX FRAME], IMPACT, [AUTO-LOCK], WHITE FRAME, 18 x16 Screen

LOW E 366, Insulated, BOX FRAME

ROLL FORMED Half Screen

Classic Contour SDL, STANDARD GRIDS, SCREEN

AAMA Std. Gold Labeling

4 WIDE, 1 HI GRIDS IN FIXED

WHITE, FPA #17791.1


Clr. Opng. MEETS EGRESS, ID: 2

Dimensions

TIP: 44 1/4 x 67 ACTUAL: 43 x 65 3/4 SCREEN: 18 X 16

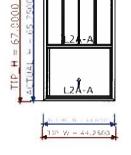Version 1





6100-SH- NFRC Rating: CWS-K-29-00648-00001 / U-Factor=0.28, Solar SHGC=0.22, V-Transmit=0.5

Item No. 2

Qty: 1

Model: 6100-SH Color: WHITE

Desc: Series 6100 Storm Strong Single Hung DP:+50/-50, [BOX FRAME], IMPACT,

[AUTO-LOCK], WHITE FRAME, 18 x16 Screen

LOW E 366, Insulated, BOX FRAME

ROLL FORMED Half Screen

Classic Contour SDL, STANDARD GRIDS, SCREEN

AAMA Std. Gold Labeling

11 HI

GRIDS IN FIXED

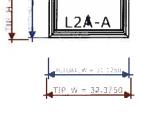
WHITE, FPA #17791.1

DOES NOT MEET EGRESS, ID: 3

Dimensions

TIP: 32 3/8 x 34 7/8 ACTUAL: 31 1/8 x 33 5/8 SCREEN: 18 X 16





6100-SH- NFRC Rating: CWS-K-29-00648-00001 / U-Factor=0.28, Solar SHGC=0.22, V-Transmit=0.5

Item No. 3

Qty: 1

Model: 6100-SH Color: WHITE

Desc: Series 6100 Storm Strong Single Hung DP:+50/-50, [BOX FRAME], IMPACT, [AUTO-LOCK], WHITE FRAME, 18 x16 Screen

LOW E 366, Insulated, BOX FRAME

LOVY E 300, ITISUIAIEU, BOX FRAIVIE

ROLL FORMED Half Screen

Classic Contour SDL, STANDARD GRIDS, SCREEN

AAMA Std. Gold Labeling

1 HI

GRIDS IN FIXED

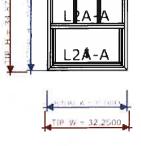
WHITE, FPA #17791.1

DOES NOT MEET EGRESS, ID: 4

Dimensions


TIP: 32 1/4 x 34 7/8 ACTUAL: 31 x 33 5/8 SCREEN: 18 X 16






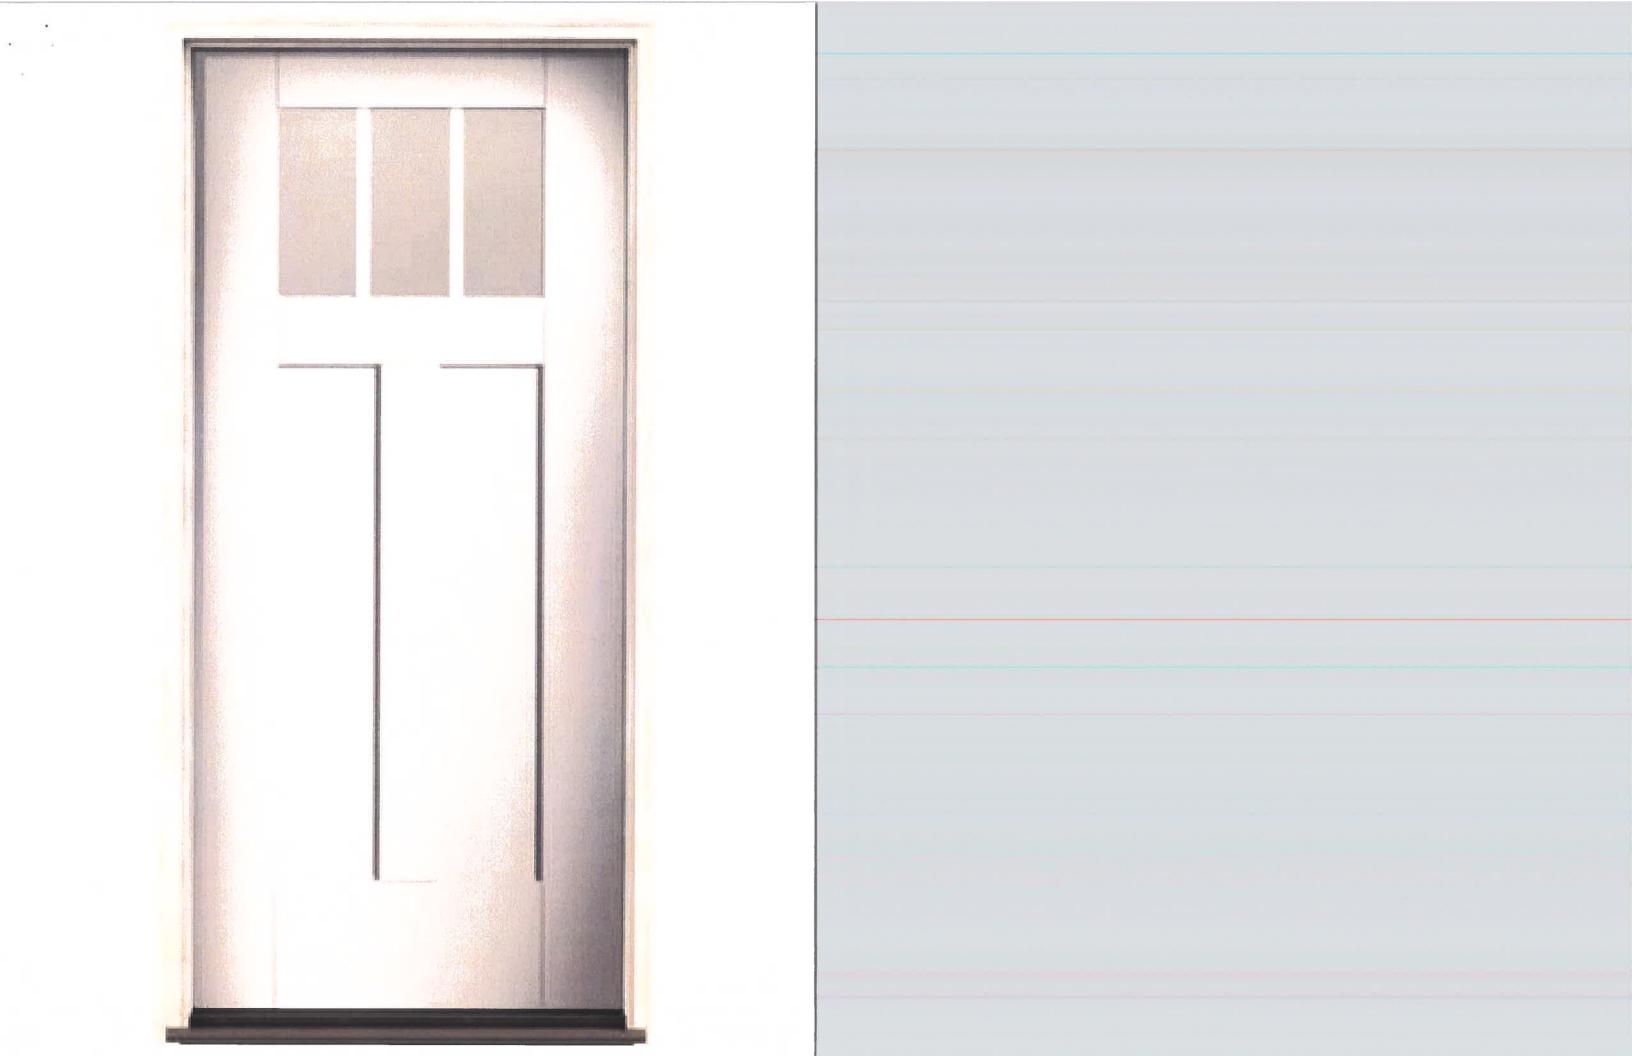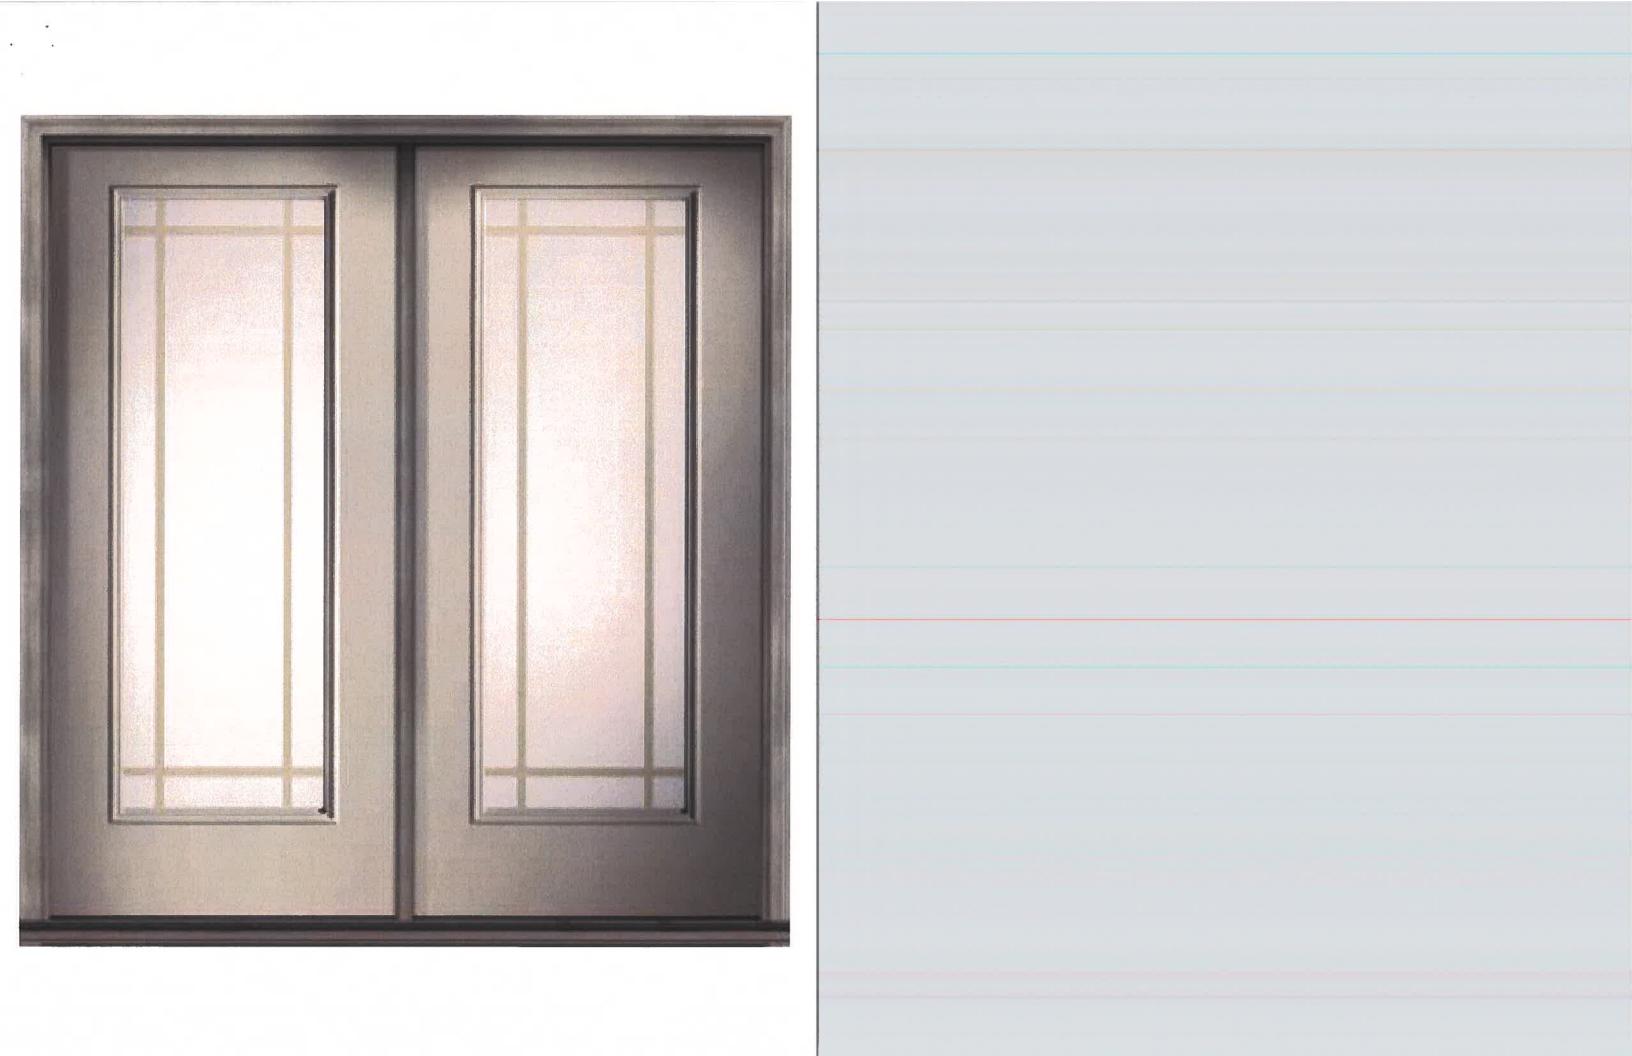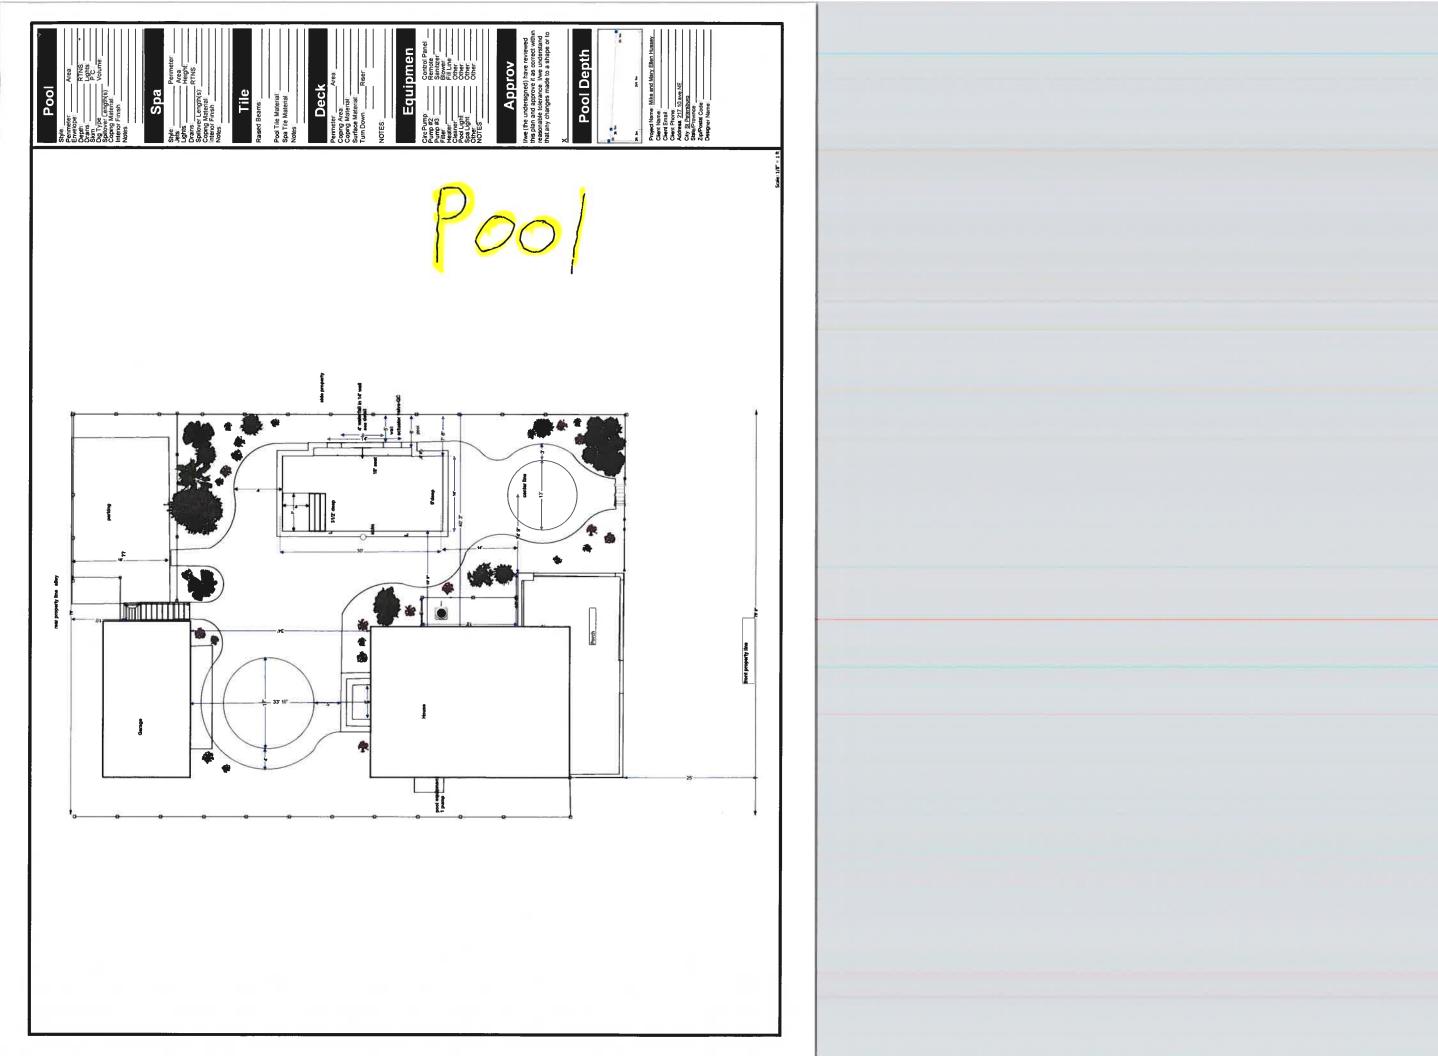
6100-SH- NFRC Rating: CWS-K-29-00648-00001 / U-Factor=0.28, Solar SHGC=0.22, V-Transmit=0.5

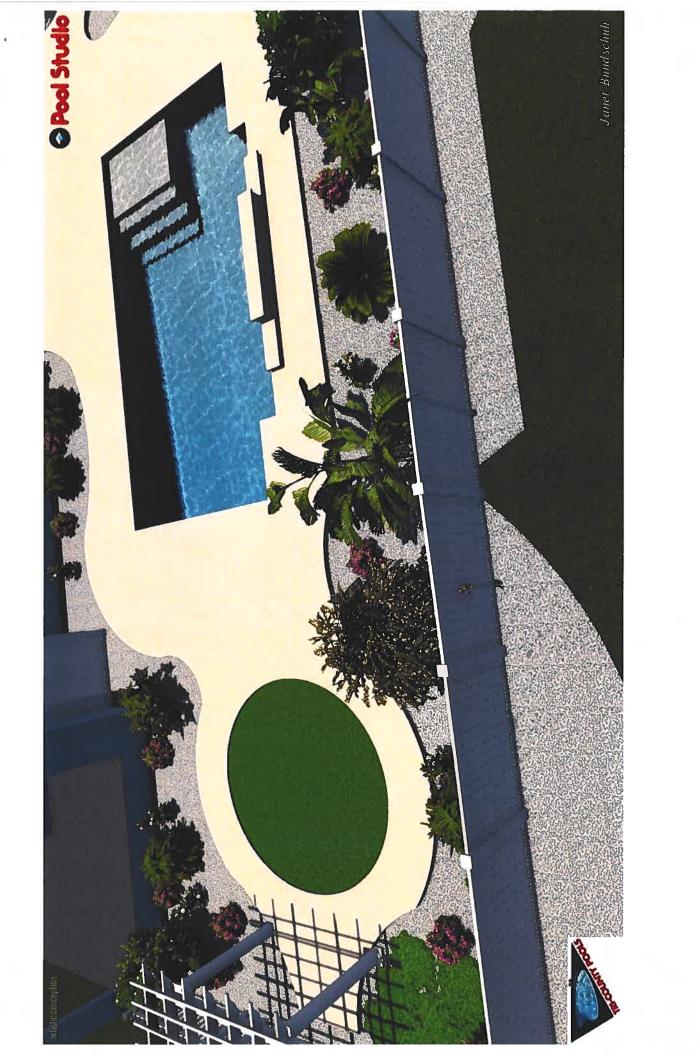
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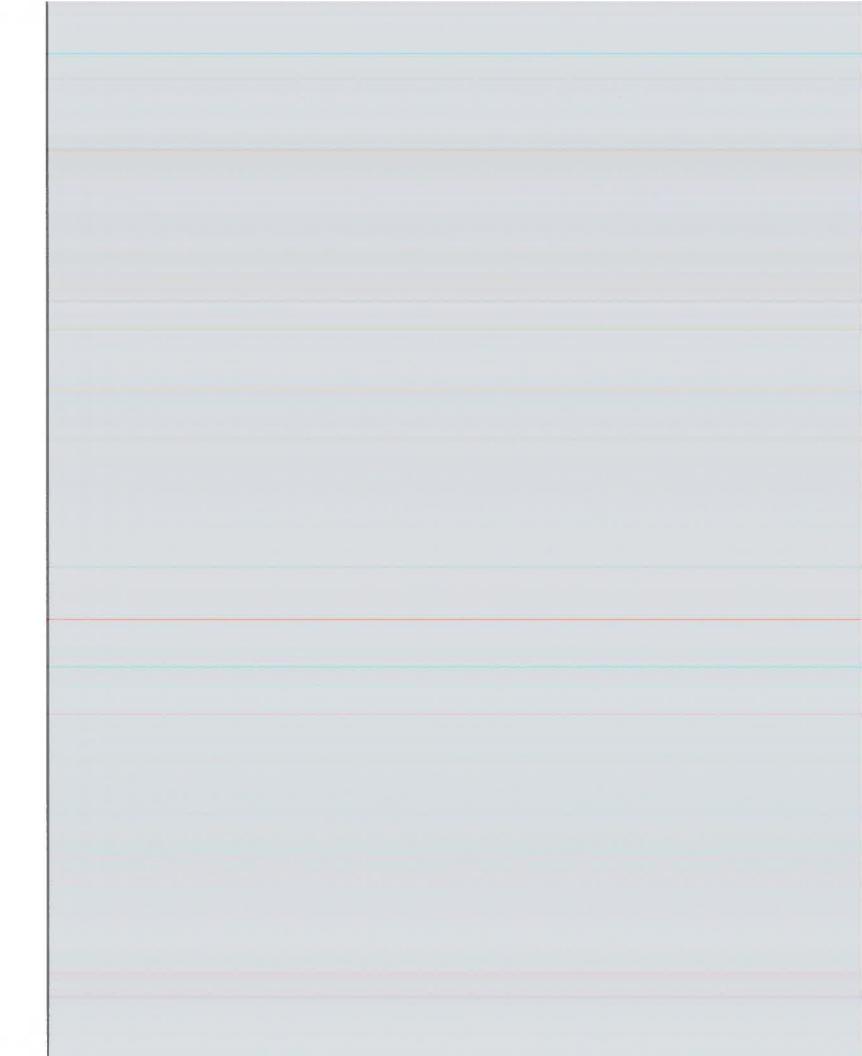


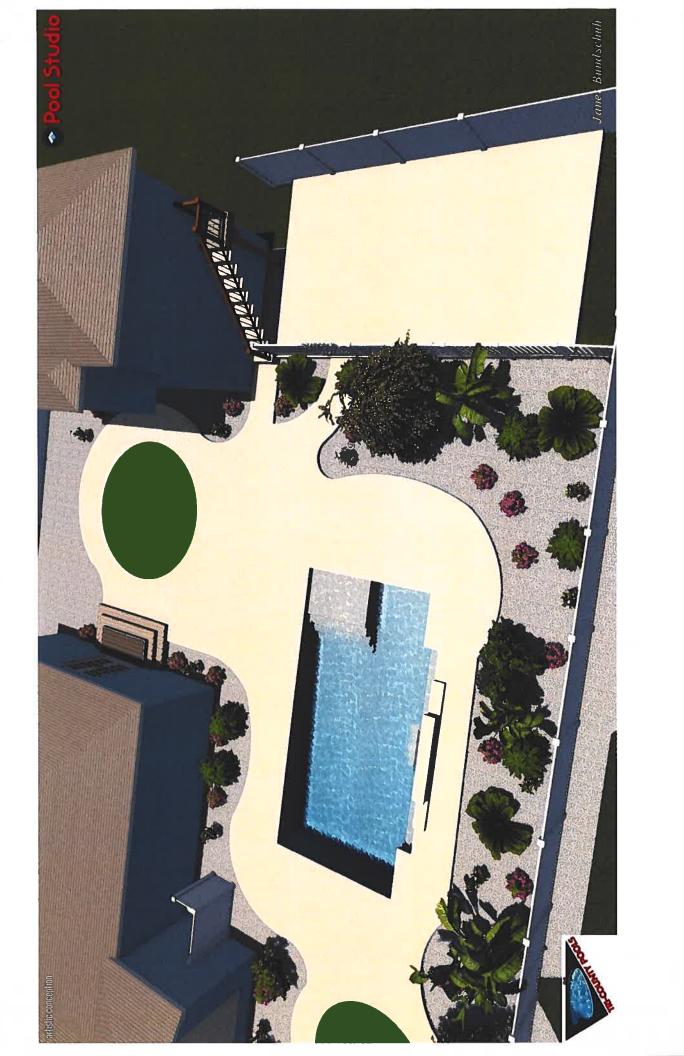


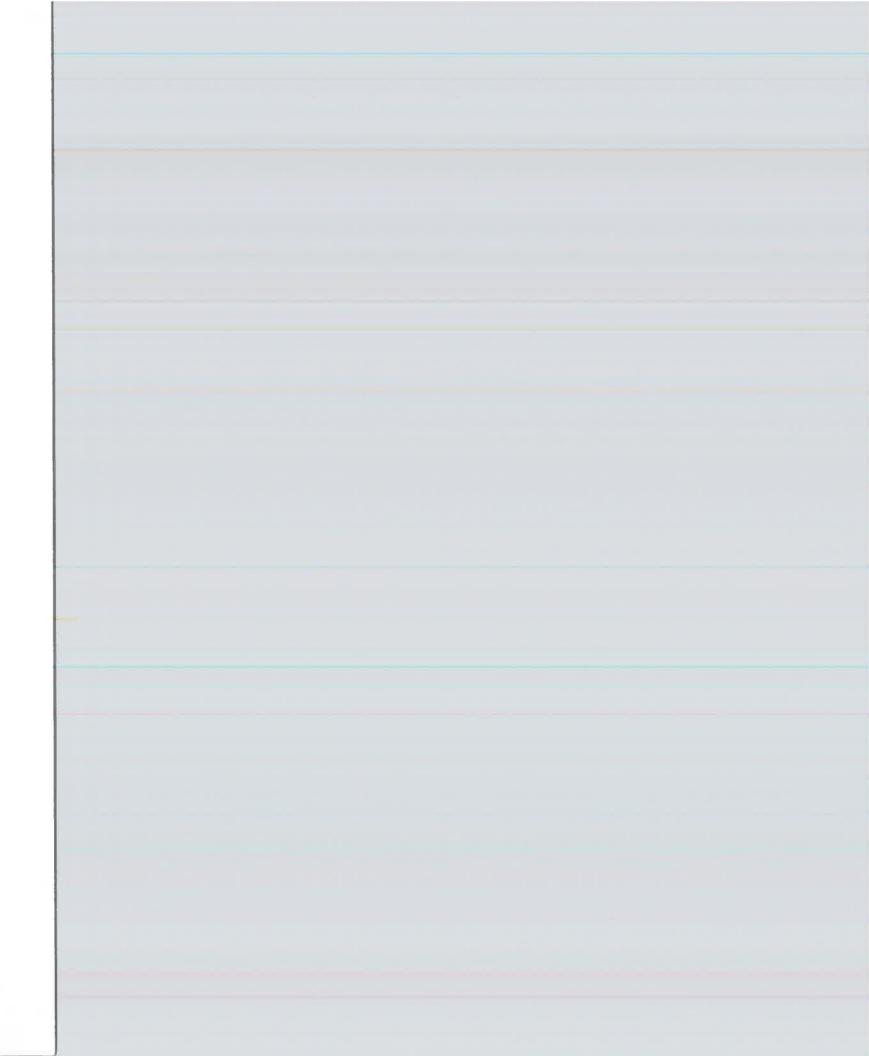


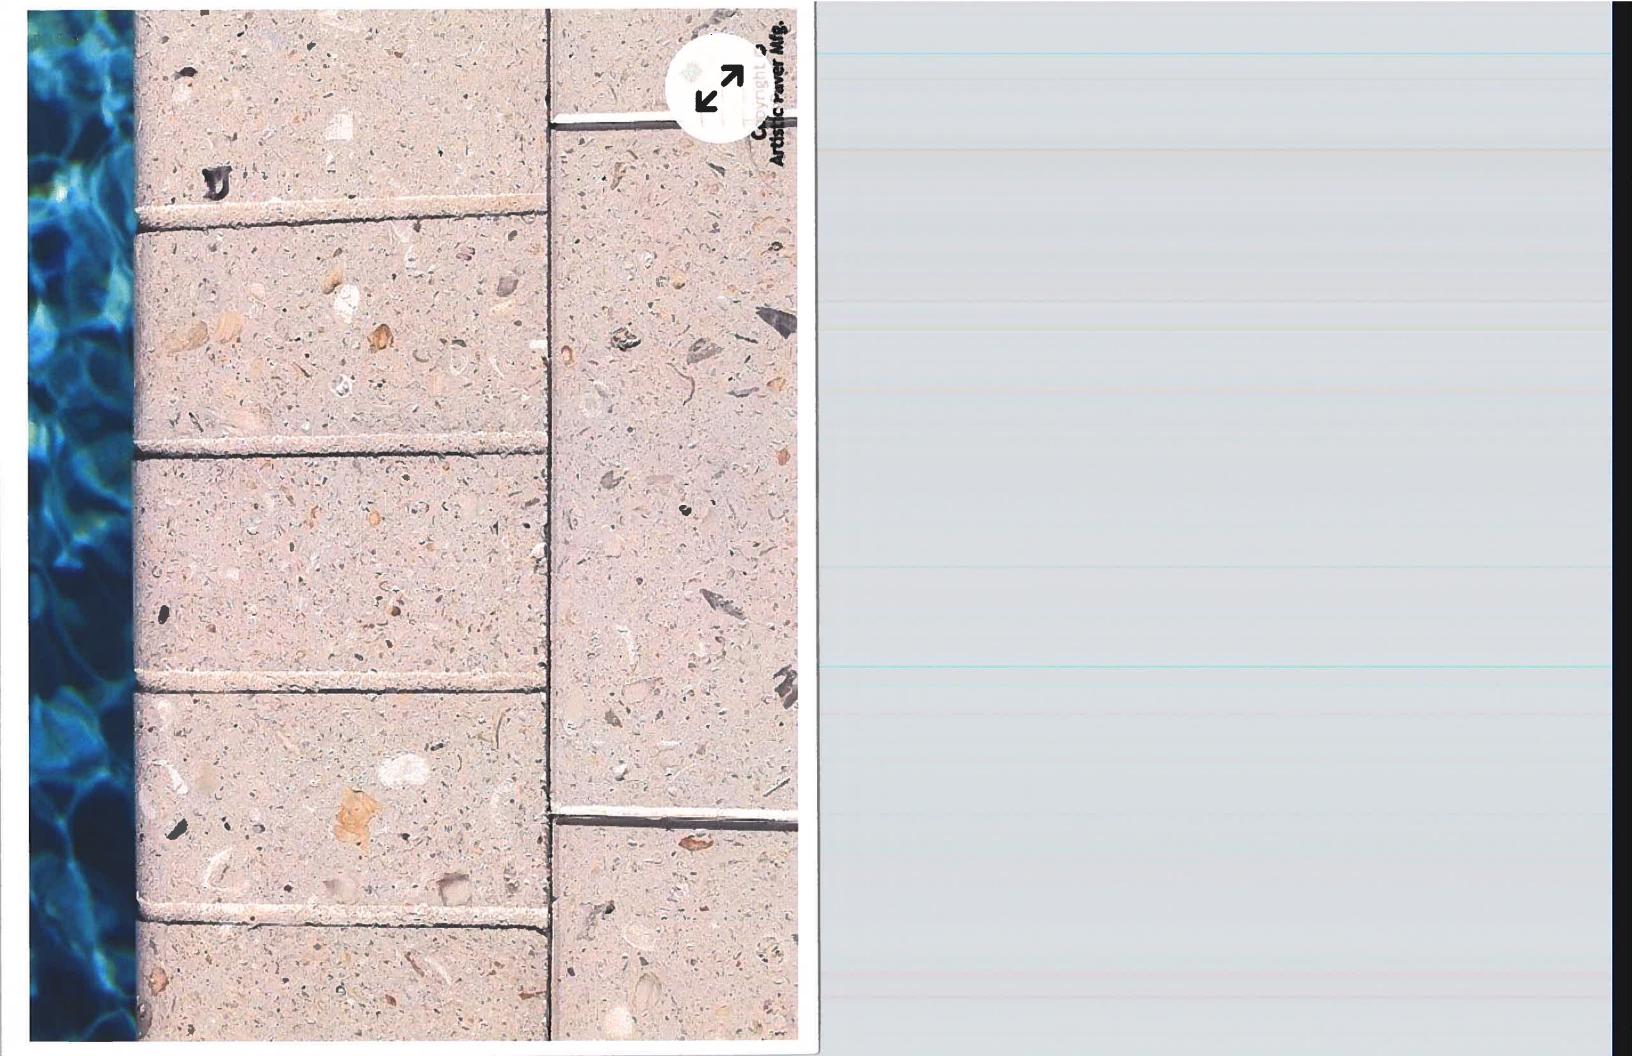












Appendix B:

Application No. 21-90400004





Property Tax Exemption Preconstruction Application Part I

Instructions: Read the attached instructions carefully before completing this application. Your application cannot be evaluated unless it is complete and all required supporting materials are provided. In the event of any discrepancy between the application for and other supplementary material submitted with it (such as architectural plans, drawings and specifications), the application form shall take precedence. Type or print clearly in black ink. If additional space is needed, attach additional sheets.

A.	A. General Information (to be completed by all applicants)			
1.	Property Identification and Location			
		31-17-05274-008-0090 (Attach legal description)		
Address of property: Street 217 10TH Avenue NE				
City	St. Petersburg County	Hittsborough Zip Code 3370 Pinellas		
		Pinellas		
2.	Qualifying Property Information:			
me p	property is: individually listed on National Register	glocally designated historic landmark		
		in a locally designated district		
3. Type of request: Exemption under 196.1997, F.S. (standard exemption) Exemption under 196.1998, F.S. (Exemption for properties occupied by non-profit organizations or governmental agencies and regularly open to the public.) See section C on page 2.				
4.	Owner Information:			
		Michael and Mary Ellen Hussey		
Name	ling Address <u>855 Central Avenue</u> , #	H310		
Mailir	St. Police Charles	FI 7.01 23001		
City_	State	FL Zip Code 33701		
Daytir	time Telephone Number <u>800 - 7 9 9 - 43</u> e property is in multiple ownership, attach a list of al	ll owners with their mailing addresses		
ii ine	e property is in moniple ownership, allach a list of al	ii owners with their maining dadresses.		
applic Coun exemp	that I own the property described above or that I am the lication, I agree to allow access to the property by aporty for the purpose of verifying the information proving the information proving the property of the property agree to maintain the character of the property	ormation I have provided is, to the best of my knowledge correct e authority in charge of the property. Further, by submission of this propriate representatives of the City of St. Petersburg or Pinellas ided in the application. I also understand that, if the requested enant with the City of St. Petersburg and Pinellas County in which and the qualifying improvements for the term of the exemption		
Name	ne May Eller Husean Signa	ature Date Date		
Complete the follwing if signing for an organization of multiple owners:				
	+			
Title	Orgo	anization Name		

В.	Property Use (To be completed by all applicants)		
1.	Use(s) before improvement: Single family residence with	th detached garage and apartme	
2.	Proposed uses(s): Primary residence		
C.	Special Exemption (complete only if applying fo non-profit organization or government agency and	r exemption under s. 196.1998, F.S., property occupied by regularly open to the public)	
1.	Identify governmental agency or non-profit organize	ation occupying the building or archaeological site.	
2.	How often does this organization or agency use the	building or archaeological site?	
3.	For buildings, indicate the total usable area of the building in square feet. (for archaeological sites, indicate the total area of the upland component in acres)		
4.	How much area does the organization or agency use?%		
5.	What percentage of the usable area does the organization or agency use?%		
6.	Is the property open to the public? ☐ Yes ☐ No If so, when?		
7.	Are there regular hours? Yes No. If so, what are they?		
8.	Is the property open by appointment? ☐ Yes ☐ No	\$ 200 AND	
9.	Is the property open ONLY by appointment? Yes No		
D.	Description of Improvements (to be completed by all applicants): Describe in the blocks below, site work, new construction, alterations, etc. Attach photographs and maps.		
App Desc of Po	rch ceiling evidences water trusion	Describe work and impact on existing feature: Original open concept parch design was elimated by and installation of windows and front entry door, water intrasion from roof flashing/windows has damaged porch ceiling Will repair parch ceiling remove all extenor windows and door from parch conversion. From parch conversion. Returning porch to its original design as an open porch.	
Phot	to no. 1 thru 1-6 Drawing no.		













Approximate date of feature: 1920

Description and condition of feature:

Live Knob and tube wiring found throughout primary home and garage/apartment of oth insulated wire in electrical panel ated meter box in garage (fused electrical ponel in garage)

Non grounded, throughout primary home and garage/apartment

Describe work and impact on existing feature:

Extensive electrical issue at

subject property

will rewise primary home and

garage/apartment to neet code

garage/apartment and outlets

All metaboxes and outlets

replaced to neet code

Photo no. 21 How 2-6

Drawing no.

Approximate date of feature: Various years

Description and condition of feature:

HVAC located to cated in attic

Stylears old and not cooling

to a proper level. Water damage

evident on 2nd floor colling

beneath unit

HVAC System servicing porch

conversion is 25 years old and

conversion is 25 years

behind primary home

HVAC system behind primary home

of years old and appears to

have not been properly maintained

have not been properly maintained

converse apartment serviced by and

old window unit.

Photo no.3-1 HN 3-8 Drawing no.

Describe work and impact on existing feature:

Extensive HVAC ISSUES at

subject property

Nill remove all HVAE equipment

In primary home and abartment

In primary home and placed

Single unit to be placed

outside primary home to address

outside primary home to address

all HVAC needs. All new duct

all HVAC needs. All new duct

work installed as well

work installed as well

work installed in the garage and

apartment

Approximate date of feature: 1920

Description and condition of feature:

Older galvanized vater pipes

and cast iron drain pipes

and cast iron drain pipes

evaluated to confirm integrity

Nater damage on subfloor

beneath half both

Water heater in laundry heater
is 2 years old and water heater
in garage water heater has improper

Garage water heater has improper

Garage water heater

Photo no. 4-1 thru 4-6 Drawing no.

Describe work and impact on existing feature: the Will thoroughly retiew of the plumbing and where needed, plumbing and where needed, plumbing and the Remodeling Kitchen and the Remodeling Kitchen and flooring majority of plumbing and flooring majority of plumbing and flooring results.

Replacing all Water heaters on property












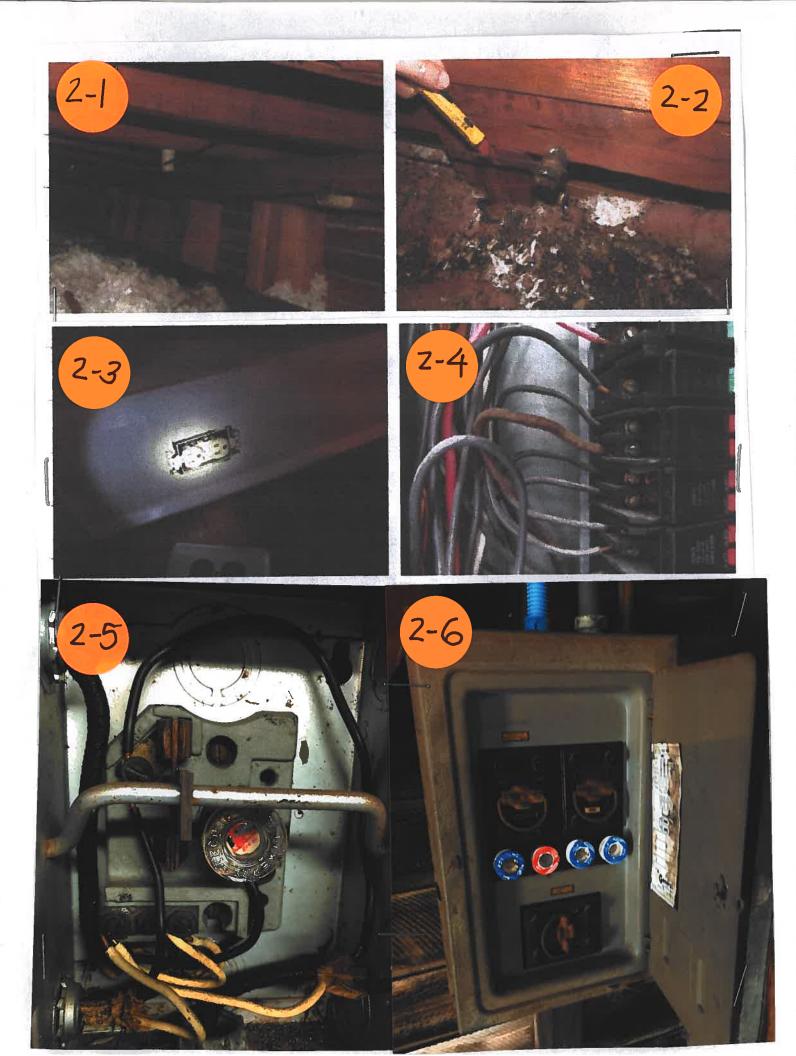







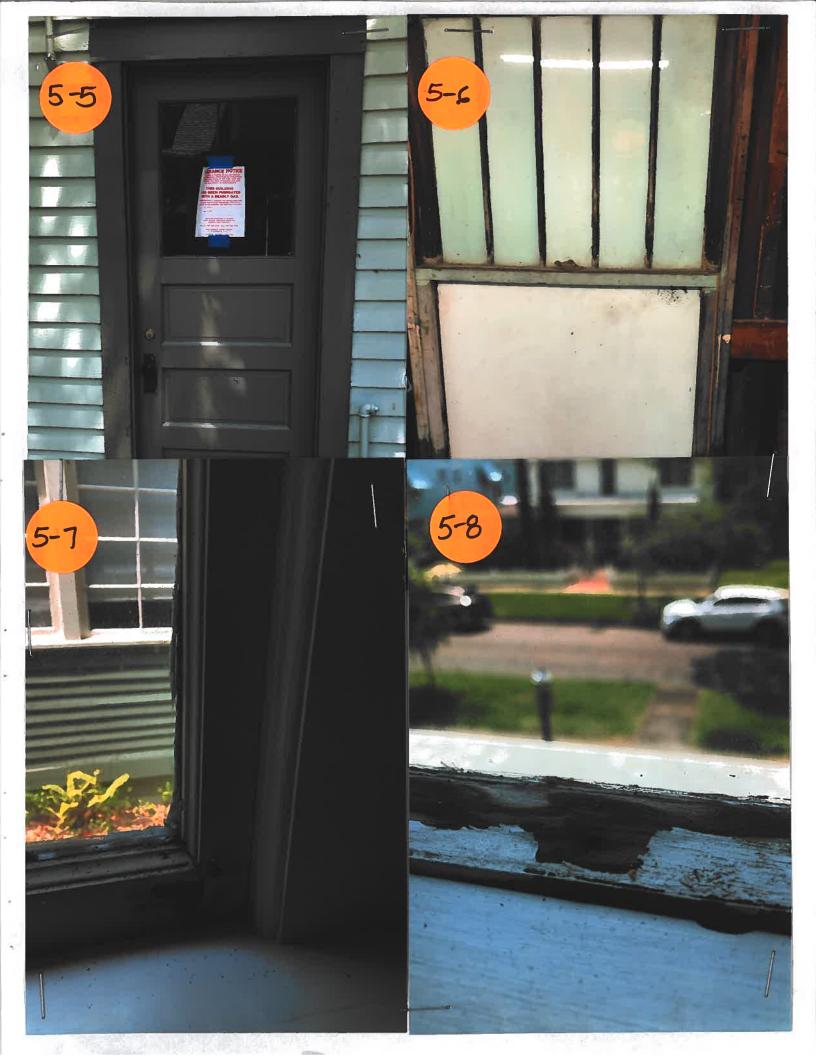


Photo no.

Drawing no.

Feature 5: Windows and Doors Approximate date of feature: 1920 Description and condition of feature: Significant visible water damage ency many non-operational older windows Windows Provide 10 UV protection. Windows do not have a hyrricane impact designation ficont rot windows have significant rot and termite damage.	Describe work and impact on existing feature: •Will be replacing all windows dand doors with new UV profective and hurricane profective and hurricane impact certified ones.
Photo no5-1 thru 5-12 Drawing no.	
Feature 6: Bothrooms and Kitchen Approximate date of feature: 1920 Description and condition of feature: Home does Not have a functioning Kitchen All bothrooms are outdated and display significant wear and are in need of updating	Describe work and impact on existing feature: New Kitchen will be designed and installed to codes have All bathrooms in primary home and apartment will be updated.
Feature 7:	Describe work and impact on existing feature:
Approximate date of feature: Description and condition of feature:	

















Appendix C:

Maps of Subject Property

